

TREE INVENTORY AND PRESERVATION PLAN River Road West Wasaga Riverwood Homes Inc. Town of Wasaga Beach Updated September 2022







September 13, 2022 RS# 2019-013

Walter Zhou

Wasaga Riverwoods Homes

via email: wzhou@wasagariverwoods.ca

SUBJECT: Tree Inventory and Preservation Plan, Part Lot 27, Concession 8 in the Geographic Township of Flos, Town of Wasaga Beach, County of Simcoe

Dear Mr. Zhou:

RiverStone Environmental Solutions Inc. is pleased to provide you with the attached report.

Please contact us if there are any questions regarding the report, or if further information is required.

Best regards,

RiverStone Environmental Solutions Inc.

Report prepared by:

Bev Wicks, Ph.D.

Senior Ecologist/Principal

Craig Mann H.B.Sc.F., Dipl. IFRM.

Civing Mann

Ecologist/ISA certified Arborist (ON-2369A)

Table of Contents

1	BAC	KGROUND	. 1
2	APP	ROACH AND METHODS	. 1
	2.1	Methods	. 1
3	DEF	INITIONS	. 1
4	TRE	E INVENTORY AND HEALTH ASSESSMENT	. 2
5	APP	LICABLE BY-LAWS AND PERMITS	.3
	5.1	Private Tree Protection By-Law	. 3
	5.2	NVCA's "Achieving Net Gains through Ecological Offsetting"	. 3
6	PRO	POSED DEVELOPMENT	. 4
7	IMP.	ACT ASSESSMENT AND RECOMMENDATIONS	. 4
	7.1	Impact Assessment	. 4
	7.1.1	Injury and Removal of Trees	. 4
	7.1.2	Preservation of Trees	. 4
	7.2	Avoidance and Mitigation Measures	. 5
8	TRE	E COMPENSATION	. 6
9	COM	MPLIANCE WITH RELEVANT POLICY AND LEGISLATION	. 6
	9.1	Federal Migratory Birds Convention Act, 1994 (MBCA)	. 6
	9.2	Provincial Endangered Species Act, S.O. 2007, c. 6	. 6
10	CC	ONCLUSIONS	. 7
L	ist of T	<u>'ables</u>	
No	table	of figures entries found.	
<u>Li</u>	st of Fi	gures equipment of the second	
Fi	gure 1.	Location of subject property	. 8
Fi	gure 2.	Tree Inventory	. 9
Fi	gure 3.	Tree Inventory and Preservation Plan	10
<u>Li</u>	st of A	ppendices	
Aj	pendix	x 1. Tree Inventory	
Aj	pendi	x 2. Proposed Development Plan	

1 BACKGROUND

RiverStone Environmental Solutions Inc. (hereafter, "RiverStone") was retained by Wasaga Riverwoods Homes Inc. to prepare a Tree Inventory and Preservation Plan for a property located on River Road West in the Town of Wasaga Beach (hereafter "subject property", **Figure 1**). The subject property is 1.04 ha in area and is legally described as Part Lot 27, Concession 8 in the Geographic Township of Flos, Town of Wasaga Beach; the property is currently undeveloped.

Historically, the subject property received draft plan approval for a residential townhouse development as part of a larger residential development application for the lands located to the south of the property. Currently, the subject property is designated Residential on Schedule A-7 of the Town of Wasaga Beach Official Plan (Consolidation February 2016). Mapping available from the Nottawasaga Valley Conservation Authority (NVCA) identifies the entirety of the subject property as being within their regulated area.

2 APPROACH AND METHODS

2.1 Methods

The tree inventory was completed on July 8, 2020, by Craig Mann (arborist) and Joel Gauthier (Technician). Trees >15 cm diameter at breast height (DBH) were inventoried, identified to species, and assessed based on health and condition. Tree information recorded for each specimen included:

- · Tag Number,
- Species (common and scientific name),
- · Diameter at breast height (DBH),
- · General condition (health and structure),
- · Canopy radius,
- · Comments, and
- · GIS location.

All trees >15cm DBH on the subject property have been tagged with either aluminum numbered tree tags or flagging tape with a tree number identified, affixed to the trunk (e.g., 524). Trees located on private lands have been labelled letter and number (e.g., A1) and were not tagged.

These results will be used to inform the detailed design and to prepare a tree preservation plan that responds to the impacts of the detailed design.

3 <u>DEFINITIONS</u>

The following definitions have been utilized in this report, inventory table, or to assess trees in the field.

Tree Number – Tag number applied in the field used in referencing trees on maps and inventory tables

Species – The scientific and common names of each tree

DBH – The diameter in centimetres of a tree at breast height, measured at 1.37 m above the ground **Inclusion** – Location where multiple stems meet and form a junction where a weak union may be present

Tree Health Condition – Overall health of the tree based on the crown

Tree Structure Condition – Overall condition of the tree based on the presence of defects, inclusions, and branching on the stem and in the crown

Good – The assessment of a tree with observed deficiencies less than 15% within a tree's health and structure condition

Fair – The assessment of a tree with observed deficiencies between 15%-40% within a tree's health and structure condition

Poor – The assessment of a tree with observed deficiencies greater than 40% within a tree's health and structure condition

4 TREE INVENTORY AND HEALTH ASSESSMENT

At the time of our site visit completed on July 8, 2020 the project area was primarily in a natural state with upland mixed forest covering the southern portion and a treed swamp community in the north portion fronting onto River Road. This report provides an inventory of trees that will be removed with property development along with trees adjacent to the development area that may be impacted. An inventory was also completed for the 6 m wide storm water easement along the east property boundary and the area of the future sidewalk along River Road West. This inventory does not include the "Nature Preserve" potion of the property (**Figure 1** and **Figure 2**).

A total of three hundred seventy-three (373) trees were assessed in this study (tree tag's 236 to 586 and numbers A1 to A7, A8 to A10, B1 to B6 and B8 to B10). This includes four (4) trees that were assessed as separate trees but under one tag number. Trees inventoried consisted of a mix of deciduous and coniferous species that are young to mid-mature. They range in size from 15 to 52.2 cm in DBH with most trees falling within the 15 to 25 cm DBH range. Of the three hundred seventy-three (373) trees tagged and assessed twelve (12) different species were documented with Green Ash (*Fraxinus pennsylvanica*) being the most abundant, followed by Red Maple (*Acer rubra*), Trembling Aspen (*Populus tremuloides*), Balsam Fir (*Abies balsamea*), White Birch (*Betula papyrifera*), Northern White Cedar (*Thuja occidentalis*), Northern Red Oak (*Quercus rubra*), Bigtooth Aspen (*Populus grandidentata*), Black Cherry (*Prunus serotina*), Willow species (*Salix* sp.), White Spruce (*Picea glauca*), and Eastern Hemlock (*Tsuga canadensis*). The complete inventory of trees can be found in **Appendix 1**.

Overall, the over health of the trees present was good considering the large amount of Green Ash and early successional species present on the subject property. A few trees had poor structure due to inclusion wood, sever lean, and large wounds. The canopy structure of most trees was good. However, a number of trees had poor canopy vigour and significant foliage dieback likely caused by a combination of Emerald Ash Borer, caterpillar foraging, and water table fluctuation. Observations of decline and defects present in trees inventoried on the property included:

- Deadwood in the canopy <15% not caused by shading
- · Inclusion wood at stem or large branch unions
- Multiple stems
- Large lateral branches
- Severe lean
- Overtop suppressed
- · Wounds on stem or branches including cavities, seams, or splits
- Defoliation caused by insects
- Discolouration of leaves or needles
- Emerald Ash Borer damage/mortality

5 APPLICABLE BY-LAWS AND PERMITS

Private lands are subject to the provisions of the Town of Wasaga Beach's Tree Cutting by-law 2019-82. Pertinent by-laws / directives are discussed below.

Trees located on private lands are subject to the provisions of the Wasaga Beach's Tree Cutting Bylaw 2019-082. This by-law prohibits the removal of trees on properties greater than 1 ha and on lands within a Natural Heritage System as outlined on Schedule D of the Town's Official Plan. The subject property is covered by both criteria.

As mentioned above, the Nottawasaga Valley Conservation Authority (NVCA) identifies the entirety of the subject property as being within its regulated area. It was determined during a site walk with the conservation authority that only the front portion of the property is a wetland community, as mapped on **Figure 2**. A permit is required from the NVCA under Section 28 of the Conservation Authorities Act to permit Development and/or Interference with Wetlands (O.Reg. 172/06). An Ecological Offsetting Plan is required per the NVCA Draft Guidelines for Achieving Net Gains through Ecological Offsetting (January 2019 Draft).

5.1 Private Tree Protection By-Law

The Town of Wasaga Beach's Tree Cutting By-law applies to trees located on private property within the Town of Wasaga Beach. Tree removal is not permitted without a permit or a condition of approval for a plan of subdivision if trees fall under the following by-law directives.

- A) Located within a woodland as defined herein;
- B) Located on lands shown as Natural Heritage System on Schedule D of the Official Plan of the Town:
- C) On all lands within the Town where the parcel measures 1 hectare in area or greater; or,
- D) On all lands zoned any category of Commercial (C) as shown on the Schedules of the Comprehensive Zoning By-law for the Town. 9.

The subject property is larger than 1.0 ha and is partly within a Natural Heritage System; however, three removal will only be completed under approval for a plan of subdivision following the by-law directives.

5.2 NVCA's "Achieving Net Gains through Ecological Offsetting"

The property contains both wetland and woodland as described in the Environmental Impact Study (EIS) prepared by RiverStone under separate cover. Compensation for the removal of both types of features are required and should be based on calculations set out in NVCA's "Achieving Net Gains through Ecological Offsetting" (draft for discussion January 20019). The NVCA document outlines two primary offsetting paths. Proponent-led offsetting requires the proponent to take responsibility for planning and implementing of an offset project based on the offsetting ratio outlined in Table 1 and Table 3 below. The other option is cash-in-lieu which provides a payment to NCVA or a qualified third-party organization to undertake an offset project (Table 2 and 4 below).

6 PROPOSED DEVELOPMENT

The proposed development as presented in the July 14, 2020 site plan AND Architecture Inc. includes a six (6) story residential building with associated parking and amenities (**Appendix 2**).

7 <u>IMPACT ASSESSMENT AND RECOMMENDATIONS</u>

7.1 Impact Assessment

This impact assessment addresses potential impacts to individual trees based on the proposed development. Impacts outlined in the following section are subject to change as a result of alterations as the design progresses. Existing trees within the subject property may be negatively affected during grading, construction, and other activities associated with implementation of residential development via the following pathways:

- Direct tree removal in areas where trees conflict with building envelopes or areas of site alteration (e.g., grading of building site and driveways, etc.);
- · Mechanical injury to the trunk, roots, branches, and/or foliage during construction activities;
- · Soil compaction within the rooting zone; and
- · Smothering or exposure of roots because of changes in grade.

Figure 3 provides an overlay of the proposed building siting with RiverStone's tree preservation/removal direction.

7.1.1 Injury and Removal of Trees

Injury to individual trees has the potential to occur when construction activities encroach into areas containing trees to be retained. No grading limit was provided at the time of writing this report, so it is assumed that all trees within the proposed development will be removed. Tree protection fencing is recommended along the east, west and south property boundaries to protect adjacent trees. Trees located directly adjacent the assumed clearing limit may be injured or require removal, mitigation is recommended (see **Section 7.2**). Tree B2, which is located along the western boundary of the subject property, is assumed to be removed since it is lying on the ground between the properties.

- Trees within the development portion of the property will require removal, these include 239, 241, 243-257, 259-457, 471, 475-480, 483, 487-499, 501-520, 523-586, B2, B5 and B6.
- Trees on adjacent lands to will require removal except for B2, this tree has a sever lean over the property line. Retained trees include 236-238,240, 242,258, 458-470, 472-474, 481-482, 484-486, 500, 521-522, A1-A7, A9, A10, B1, B3, B4, and B8-B10
- All trees on adjacent lands and along the lot boundaries are to be considered boundary trees and may
 be impacted through root damage or damage to crown. Approvals from adjacent landowners are
 required to impact boundary trees prior to any tree removals.

7.1.2 Preservation of Trees

Tree preservation is recommended for trees where encroachment, excavation, or disturbance into the root and driplines is anticipated to be minor or non-existent, and for individuals for which tree health and stability will not be negatively impacted. Where minor encroachments may occur, mitigation measures will be employed to reduce the potential for negative impacts to individuals allowing for these trees to be preserved. With all trees within the development area being removed, tree

preservation measures will only be implemented for trees on adjacent lands and within the nature preserve.

7.2 **Avoidance and Mitigation Measures**

Due to the proximity of the proposed development to the driplines of trees to be retained, these specimens require protection measures to be implemented. RiverStone recommends the following measures:

- If there is a requirement to remove or prune trees that are overhanging the property boundary with adjacent landowners (shared trees), consent from adjacent landowner must be acquired before commencing.
- Trees along the property boundary will be monitored for damage and health during and post construction with maintenance or remove completed to any poor health or damaged trees once construction is complete. Maintenance and or removal must be consented by the property owner prior to completion and compensation may be required. Machinery movement, or storage of any equipment or materials should occur as little as possible within the adjacent to retained trees.
- Detailed redevelopment and grading plans for subject property must consider all trees on adjacent properties as mapped on Figure 3 as design constraints.
- At a minimum, tree protection fence should be installed along the boundary of the west and south property boundaries to protect trees on adjacent lands.
- In the event of mechanical injury to any trees recommended for retention and/or their branches, or if pruning is required to provide clearance for construction machinery, the following best management practices are recommended:
 - o Prune damaged limbs cleanly and according to standard arboricultural practices.
 - Prune damaged roots that have been exposed cleanly and according to standard arboricultural practices.
 - o Trim loose bark but avoid enlarging any open wounds.
- In locations where excavation will occur within 4 m of adjacent trees, Horizontal Root
 Protection in conjunction with hydro-excavation is recommended to reduce the potential for
 compaction. Root protection is to include:
 - o Installation of 4'x8' plywood boards (minimum ¾'' thick) length wise over the root zone area between the trunk and limit of excavation were possible.
 - o Boards are to be installed on top of a 50mm depth shredded bark mulch base.
- Tree or vegetation removal and other disturbances outside of the development envelopes should not occur without prior approval.
- If excavation must occur within 4 m of trees located on adjacent lands, hydro-excavation / air spading is recommended to minimize the damage to roots. The following methods are to be applied where hydro- excavation is recommended:
 - At the limit of excavation, hydro-excavate to a depth of 150 mm along the length of the buffer distance and at a width of 0.5 m to expose roots.

- Prune any roots in this area using good arboricultural practices per the guidelines in this report or under the supervision of a Certified Arborist.
- Backfill with excavated material and reinstate to original condition or better.
- o Upon completion reinstate tree protection fencing to original location.
- o Water trees periodically during construction.
- At the completion of construction, apply 100mm depth shredded bark mulch within the root zone of adjacent trees (may vary depending on tree location).

8 TREE COMPENSATION

The proposed development requires the removal off all trees within the development area. Based on Section 3.3.2 Quantifying the Area of Gain – Wetland from the NVCA's guidance document, the following table outlines the compensation requirements for the removal of 0.33 ha of swamp community delineated in the field by RiverStone and confirmed by NVCA staff in 2019. The base compensation offsetting ratio is 1:1 with an increase in offsetting ratio based on influencing factors as outline in table below. The extent of the wetland and woodland communities are provided on **Figures 2** and **3**. The Wetland Offsetting Plan was completed by RiverStone in June 2021 with an offsetting price of \$109,080 for the removal of trees within the wetland community. An agreement from the NVCA outlining the terms of the offsetting payment and confirmation of the amount has been received.

9 <u>COMPLIANCE WITH RELEVANT POLICY AND LEGISLATION</u>

9.1 Federal Migratory Birds Convention Act, 1994 (MBCA)

Section 6 of the Migratory Birds Regulations under the MBCA makes it an offence to "disturb, destroy or take a nest, egg, nest shelter, eider duck shelter or duck box of a migratory bird."

Restricting clearing of vegetation for the proposed development to times outside of the period May 1 to August 31, will prevent contravention of Section 6 of the regulations.


If development and site alteration is going to occur during this period, a nest survey should be conducted by a qualified avian biologist prior to commencement of construction activities to identify and locate active nests of migratory bird species covered by this Act. If a nest is located or evidence of breeding noted, then a mitigation plan should be developed to address any potential impacts on migratory birds or their active nests. Mitigation may require establishing appropriate buffers around active nests or delaying construction activities until the conclusion of the nesting season.


9.2 Provincial Endangered Species Act, S.O. 2007, c. 6

The *Endangered Species Act* (ESA) protects designated Endangered and Threatened species in Ontario from being killed, harmed, or harassed (s. 9) or having their habitat damaged or destroyed (s. 10). To comply with the ESA, all land clearing and vegetation removal be completed outside of the active season for endangered and threatened species (i.e., removal is to occur between November 1 and April 15).

10 <u>CONCLUSIONS</u>

Provided that RiverStone's proposed recommendations and mitigation measures outlined herein are implemented in full, we believe that this tree inventory and preservation plan meets the requirements of the Town of Wasaga Beach and the NVCA Tree Protection and Compensation Guidelines.

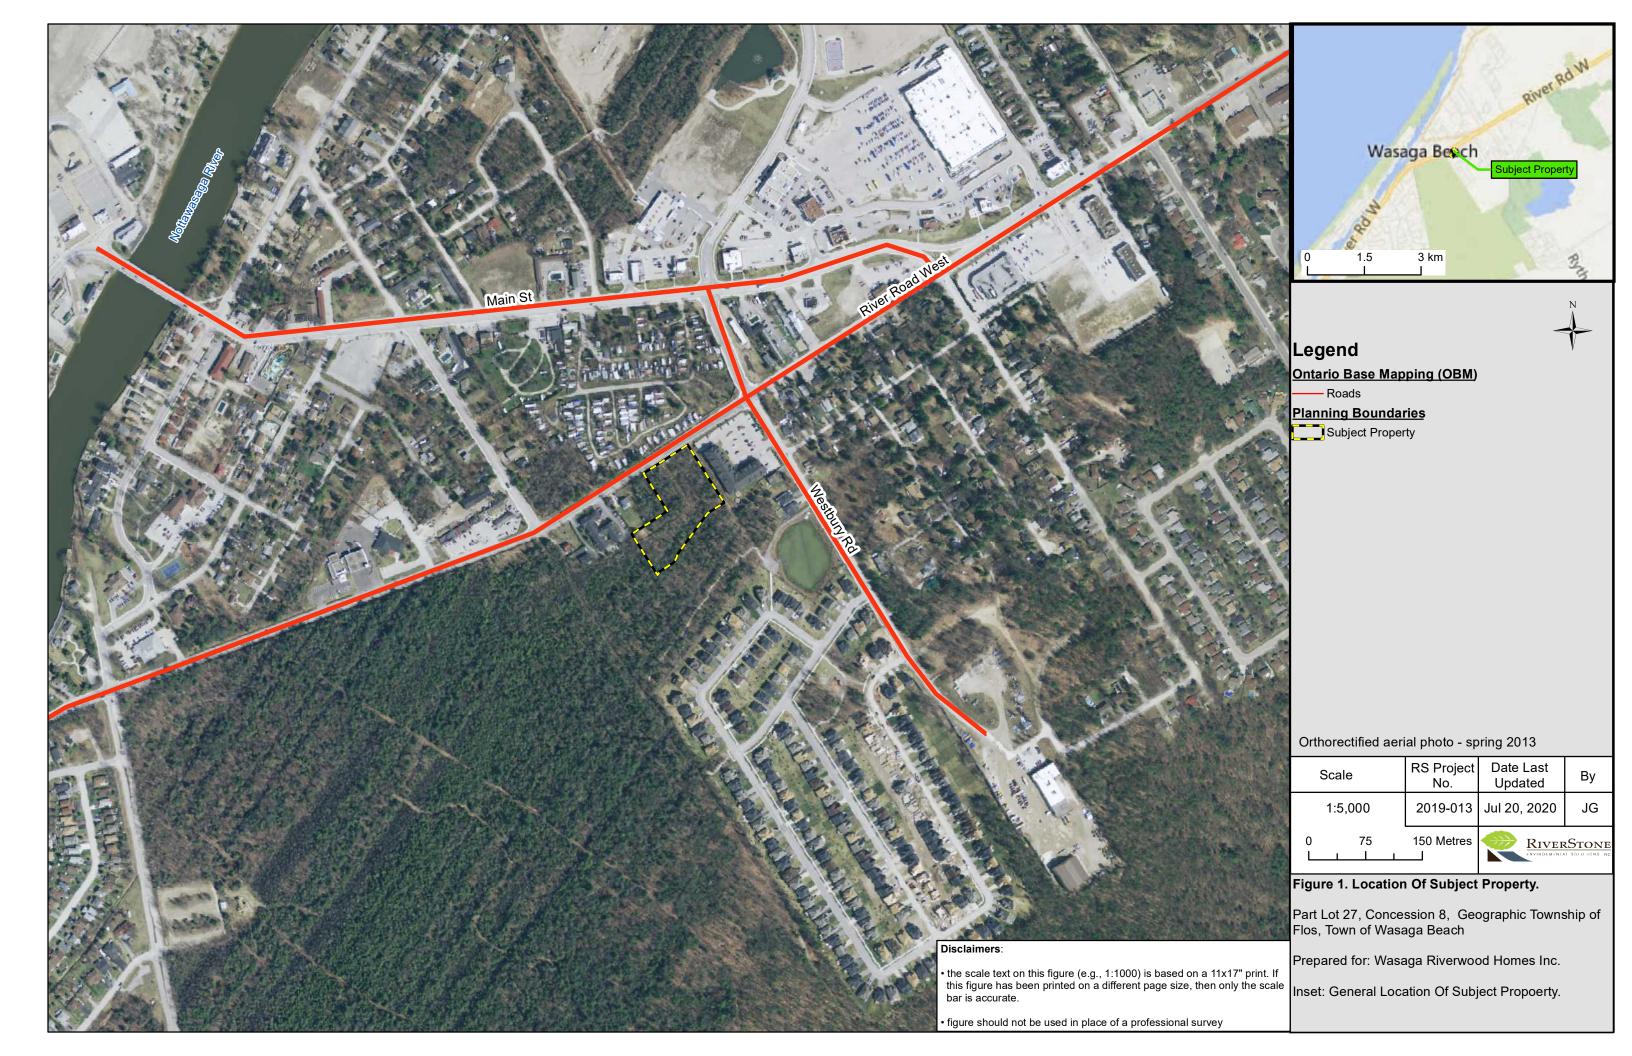

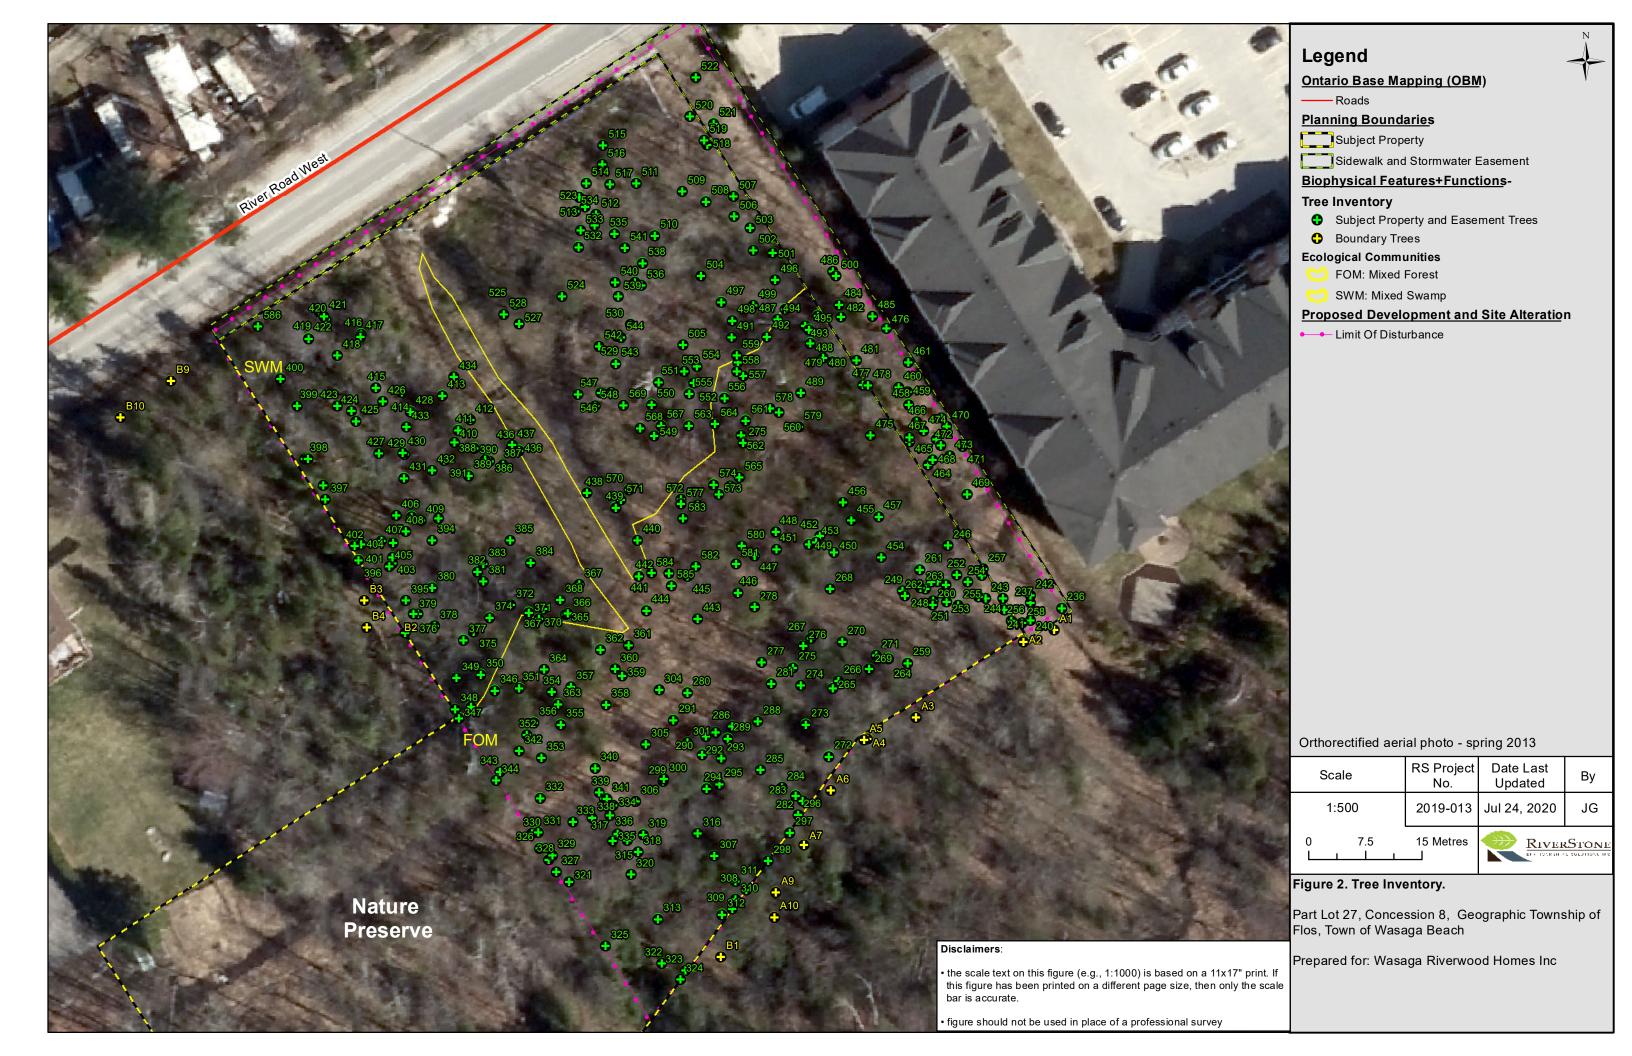

Appendix 1. Tree Inventory



Appendix 1. Tree Inventory

RS Job #: 2019-	013	<u>Staff</u>		Assessm	ent Crite	ria and Coi	ndition_		
Client: Wasaga	Riverwoods Homes Inc.			Trunk In	tegrity (T	I): defects	of weakness in tr	unk, etc.	Good (G): tree displays less than 15% deficiency or defect
		Certified Arborist: Craig							
		Mann	2369A						
Date of On-site	Inventory: July 8, 2020			Canopy S	Structure	(CS): scaff	old branches, uni	ons, multiple stems, insect da	r Fair (F): tree displays 15-40% deficiency or defect
Weather: Sunn	y with limited breeze.	Assistant: Joel Gauthier							
			Canopy \	/igour (C	V): health	of tree based on o	rown	Poor (P): tree displays greater than 40% deficiency or defect	
					Conditio		Canopy Radius	Recommendation	
Tag No.	Common Name	Scientific Name	DBH (cm)	TI	CS	CV	(m)		Comments
								Retain-Tree protection	
236	Green Ash	Fraxinus pennsylvanica	26.3	g	g	g	2.5	fencing	
								Retain-Tree protection	
237	Northern Red Oak	Quercus rubra	30.4	g	g	g	4.0	fencing	
								Retain-Tree protection	
238	Trembling Aspen	Populus tremuloides	27.0	g	g	g	2.5	fencing	
239	Green Ash	Fraxinus pennsylvanica	16.8	g	g	g		Remove	
								Retain-Tree protection	
240	Green Ash	Fraxinus pennsylvanica	16.4	g	g	g		fencing	
241	Trembling Aspen	Populus tremuloides	20.2	g	g	g	3.0	Remove	
								Retain-Tree protection	
242	Trembling Aspen	Populus tremuloides	19.8	T T	g	g	2.0	fencing	trunk wound
243	Northern Red Oak	Quercus rubra	21.0	g	g	g	3.0	Remove	dieback
244	Trembling Aspen	Populus tremuloides	21.6	Т	g	g	2.5	Remove	lots of dead shaded stubs
0.45	Tuo wala lina w A ana an	Danish a transistate	21.1	_	-	£	2.0	Damasus	lots of branch spikes, insect damage on leaves, shared stump with
245	Trembling Aspen	Populus tremuloides	31.1 17.7	р	g	l a	3.0	Remove	246
246	Trembling Aspen	Populus tremuloides	23.9	dood	р	g	2.0	Remove	overtop suppressed, dieback, lean, shared stump with 245
247	Trembling Aspen	Populus tremuloides		dead	a	~	2.0	Remove	shares stump with multi stems, inclusion wood
248	Red Maple	Acer rubra	15.2	h	g	g	3.0	Remove	Shares stump with multi stems, inclusion wood
249 250	Green Ash Green Ash	Fraxinus pennsylvanica Fraxinus pennsylvanica	18.7 17.2	dead	a	n	3.0	Remove Remove	wound on trunk, abundant dieback, epicormic branching
251	Green Ash	Fraxinus pennsylvanica	20.1	dead	y	ρ	3.0	Remove	wound on trunk, abundant dieback, epiconnic branching
252	Balsam Fir	Abies balsamea	18.0	ueau	f	α	1.0	Remove	flat top
252	Trembling Aspen	Populus tremuloides	24.4	9	f	y n	3.0	Remove	crook in canopy
253	Trembling Aspen	Populus tremuloides	25.2	9	n I	9	2.5	Remove	GOOK III CATIOPY
255	Green Ash	Fraxinus pennsylvanica	52.2	9	g	g	3.0	Remove	
256	Trembling Aspen	Populus tremuloides	19.4	n y	y n	y n	2.5	Remove	wounds on trunk, insect damage on leaves, dead top
257	Red Maple	Acer rubra	20.3	n D	Q Q	n d	2.5	Remove	shared stump with 12 stems
201	Red Maple	TICE THOIL	20.0	۲	9	9	2.0	Retain-Tree protection	Shared Starrip With 12 Sterns
258	Green Ash	Fraxinus pennsylvanica	20.3	n	a	a	2.5	fencing	
230	GICCII ASII	Traxillas perinsylvarilea	20.0	9	9	9	2.0	Retain - Tree protection	
A1	Trembling Aspen	Populus tremuloides	25.5	n	a	a	3.0	fencing	possible root and crown impact
731	Trombing ropon	1 opaids tremaioides	20.0	9	9	9	0.0	Retain - Tree protection	possible root and drown impact
A2	Green Ash	Fraxinus pennsylvanica	28.0	a	a	a	3.0	fencing	possible root and crown impact
, _	51001171311	. raminas perinsyrvariiea	20.0	1 9	9	9	0.0	101101119	possession of an an arrangement

		1					1		
					Conditio	on	Canopy Radius	Recommendation	
Tag No.	Common Name	Scientific Name	DBH (cm)	TI	CS	CV	(m)		Comments
259	Green Ash	Fraxinus pennsylvanica	23.8	g	g	g	2.5	Remove	
260	Green Ash	Fraxinus pennsylvanica	21.6	g	f	g	2.0	Remove	inclusion in canopy
261	Black Cherry	Prunus serotina	19.2	f	g	g	3.0	Remove	multiple stems at base
262	Red Maple	Acer rubra	15.2	f	g	g	2.5	Remove	multiple stems at base 5 additional
263	Trembling Aspen	Populus tremuloides	27.6	g	g	g	3.0	Remove	
4.0	Crosm Ash	Francisco mannos de combo	20.0	_	_	_	2.0	Retain-Tree protection	Amount of the second
A3	Green Ash Green Ash	Fraxinus pennsylvanica	38.9 22.7	p n	g	g	3.0	fencing Remove	trunk wound
264 265		Fraxinus pennsylvanica Populus tremuloides	22.7	p n	g	g	3.0	Remove	shared stump with 265, poor union shared stump with 264, poor union
266	Trembling Aspen Trembling Aspen	Populus tremuloides Populus tremuloides	21.3	ρ	g	9	3.0	Remove	shared sturnp with 204, poor union
267	Balsam Fir	Abies balsamea	15.9	g	g	g f	2.5	Remove	overtop
268	Green Ash	Fraxinus pennsylvanica	20.0	g	g	<u>'</u>	3.0	Remove	ονειτορ
269	Bigtooth Aspen	Populus grandidentata	20.0	<u>9</u>	<u>9</u>	n	3.0	Remove	
270	Bigtooth Aspen	Populus grandidentata	27.6	<u>9</u>	g	n	3.0	Remove	
271	Bigtooth Aspen	Populus grandidentata	21.0	g 0	g 0	g 0	3.0	Remove	
	2.g.com.nopon	. oparao granaraontata		3	9	3	0.0	Retain-Tree protection	
A4	Red Maple	Acer rubra	37.7	f	a	a	3.5	fencing	seams, trunk twist
		1,007,1000			3	3		Retain-Tree protection	
A5	Balsam Fir	Abies balsamea	17.2	f	q	a	1.5	fencing	overtop suppressed
272	Bigtooth Aspen	Populus grandidentata	18.2	q	q	q	3.0	Remove	
273	Bigtooth Aspen	Populus grandidentata	25.0	f	g	g	3.0	Remove	lean
274	Bigtooth Aspen	Populus grandidentata	22.7	g	g	g	3.0	Remove	
275	Bigtooth Aspen	Populus grandidentata	30.8	g	g	g	3.0	Remove	
276	Bigtooth Aspen	Populus grandidentata	19.7	f	g	g	3.0	Remove	lean
277	Green Ash	Fraxinus pennsylvanica	17.0	g	g	р	1.5	Remove	dieback, epicormic branching, sparse foliage
278	Green Ash	Fraxinus pennsylvanica	21.1	dead				Remove	
279	Green Ash	Fraxinus pennsylvanica	21.1	dead				Remove	
280	Trembling Aspen	Populus tremuloides	21.3	р	g	f	3.0	Remove	seam, rot observed, woodpecker damage
281	Trembling Aspen	Populus tremuloides	23.2	g	g	g	3.0	Remove	
282	Balsam Fir	Abies balsamea	19.2	р	f	g	2.5	Remove	vine in tree, trunk wound, dieback
			0.1.0					Retain - Tree protection	
A6	Green Ash	Fraxinus pennsylvanica	21.8	İ	g	g	3.0	fencing	lean
283	Trembling Aspen	Populus tremuloides	15.2	g	g	Ť	2.0	Remove	insect damage on leaves
284	Black Cherry	Prunus serotina	20.4	р	g	<u>g</u>	3.0	Remove	sever lean
285	Trembling Aspen	Populus tremulaides	17.5	<u>g</u>	g	9	2.5	Remove	
286	Trembling Aspen	Populus tremuloides	16.6	9	9	9 ~	2.0 3.0	Remove	
287 288	Trembling Aspen Green Ash	Populus tremuloides Fraxinus pennsylvanica	23.1 19.0	y c	y c	y	2.0	Remove	almost dead, dieback, epicormic branching
288	Green Ash	Fraxinus pennsylvanica Fraxinus pennsylvanica	21.5	9	9	þ	3.0	Remove Remove	dieback
289	Trembling Aspen	Populus tremuloides	17.2	9	9	ρ	1.5	Remove	low leaf abundance, insect damage on leaves, dieback
290	Green Ash	Fraxinus pennsylvanica	19.0	dead	9	ν ν	1.0	Remove	now real abundance, insect damage on reaves, dieback
291	Green Ash	Fraxinus pennsylvanica	20.0	dead			+	Remove	
293	Northern Red Oak	Quercus rubra	16.0	n	а	п	3.0	Remove	
293	Trembling Aspen	Populus tremuloides	17.2	dead	9	9	3.0	Remove	
234	I tembing Aspen	r opaius ii emulolues	17.2	ucau	<u> </u>	<u> </u>		Kelliove	

				1					
					Conditio	on	Canopy Radius	Recommendation	
Tag No.	Common Name	Scientific Name	DBH (cm)	TI	CS	CV	(m)		Comments
295	Trembling Aspen	Populus tremuloides	22.9	g	g	g	3.0	Remove	
296	Balsam Fir	Abies balsamea	17.3	g	g	g	2.0	Remove	
								Retain - Tree protection	
A7	Balsam Fir	Abies balsamea	17.0	g	g	g	2.0	fencing	
297	Green Ash	Fraxinus pennsylvanica	17.6	dead				Remove	
298	Balsam Fir	Abies balsamea	29.2	f	g	g	2.0	Remove	multiple stem, inclusion @ 8.0m
299	Trembling Aspen	Populus tremuloides	21.0	g	g	f	3.0	Remove	dieback
300	Trembling Aspen	Populus tremuloides	23.9	g	g	g	3.0	Remove	
301	Green Ash	Fraxinus pennsylvanica	21.1	р	g	g	3.0	Remove	share stump, inclusion wood, dieback
302	Green Ash	Fraxinus pennsylvanica	17.1	р	g	g	3.0	Remove	share stump, inclusion wood, dieback
303	Green Ash	Fraxinus pennsylvanica	26.5	р	g	g	3.5	Remove	share stump, inclusion wood, dieback
304	Green Ash	Fraxinus pennsylvanica	24.2	g	g	g	3.5	Remove	
305	Green Ash	Fraxinus pennsylvanica	26.6	g	g	f	3.0	Remove	insect damage on leaves
306	Green Ash	Fraxinus pennsylvanica	20.0	g	g	g	3.0	Remove	
307	Green Ash	Fraxinus pennsylvanica	16.8	dead				Remove	
308	Black Cherry	Prunus serotina	15.1	g	g	g	2.0	Remove	
		_ , , , ,						Retain - Tree protection	
A9	Green Ash	Fraxinus pennsylvanica	16.6	g	g	g	3.0	fencing	
								Retain - Tree protection	
A10	Red Maple	Acer rubra	30.0	р	g	g	4.0	fencing	multiple stems from one stump, inclusion wood
	5 114		00.0				4.0	Retain - Tree protection	
	Red Maple	Acer rubra	20.0	р	g	g	4.0	fencing	multiple stems from one stump, inclusion wood
	5 114 1		47.4				4.0	Retain - Tree protection	and thinks the second s
222	Red Maple	Acer rubra	16.4	р	g	g	4.0	fencing	multiple stems from one stump, inclusion wood
309	Northern White Cedar	Thuja occidentalis	19.9	р	g	g	2.0	Remove	sever lean, exposed roots, multiple stems, inclusion wood
310	Northern White Cedar	Thuja occidentalis	16.0	g	g	g	2.5	Remove	
311	Green Ash	Fraxinus pennsylvanica	32.7	dead	~		2.0	Remove	
312 313	Balsam Fir Red Maple	Abies balsamea Acer rubra	15.8 24.0	g	g	g	2.0 5.0	Remove	charad ctump, bark inclusion
313	Red Maple	Acer rubra Acer rubra	37.3	p	g	g	5.0	Remove	shared stump, bark inclusion shared stump, bark inclusion
314	Northern White Cedar	Thuja occidentalis	15.5	ρ	g	y	2.5	Remove Remove	shared stump, bark inclusion
316	Green Ash	Fraxinus pennsylvanica	22.9	y f	g	y	3.0	Remove	shared stump with smaller tree
317	Green Ash	Fraxinus pennsylvanica	28.0	, ,	9	y n	3.0	Remove	mostly dead
317	Green Ash	Fraxinus pennsylvanica	20.8	dead	9	ρ	3.0	Remove	mostly dead
319	Green Ash	Fraxinus pennsylvanica	18.2	ueau		f	3.0	Remove	some db
320	White Birch	Betula papyrifera	18.5	9	9		4.0	Remove	Joine ab
321	Green Ash	Fraxinus pennsylvanica	15.6	9	9	<u>y</u>	3.0	Remove	
321	Green Ash	Fraxinus pennsylvanica	17.3	9	9	<u>y</u>	3.0	Remove	
323	Green Ash	Fraxinus pennsylvanica	19.6	9	g n	g	3.0	Remove	
525	OICEII ASII	Traxillas perinsylvanica	17.0	9	9	У	3.0	Retain - Tree protection	
B1	Green Ash	Fraxinus pennsylvanica	20.6	l a	a	a	3.0	fencing	
	GICCII ASII	Traxillas perinsylvanica	20.0	9	9	9	3.0	Retain - Tree protection	
	Green Ash	Fraxinus pennsylvanica	15.0	n	n	n	3.0	fencing	
324	Green Ash	Fraxinus pennsylvanica	16.0	u g	<u>9</u>	n g	2.5	Remove	
UL-T	OLCOLLYBII	Transido porisigivarioa	10.0	<u>1</u> 9	<u> </u>	<u> </u>	2.0	I Kelliove	

					Conditio	on	Canopy Radius	Recommendation	
Tag No.	Common Name	Scientific Name	DBH (cm)	TI	CS	CV	(m)		Comments
325	White Spruce	Picea glauca	28.5	g	р	р	3.0	Remove	lots of dieback, poor crown
326	Northern White Cedar	Thuja occidentalis	18.2	g	g	g	2.5	Remove	
327	Northern Red Oak	Quercus rubra	19.6	g	g	g	3.0	Remove	
328	Bigtooth Aspen	Populus grandidentata	22.5	g	g	g	3.0	Remove	insect damage on leaves
329	Bigtooth Aspen	Populus grandidentata	21.8	g	g	g	3.0	Remove	insect damage on leaves
330	Bigtooth Aspen	Populus grandidentata	22.3	g	g	g	3.0	Remove	insect damage on leaves
331	Bigtooth Aspen	Populus grandidentata	19.7	g	g	g	3.0	Remove	insect damage on leaves
332	Northern Red Oak	Quercus rubra	32.5	р	g	g	5.0	Remove	shared stump with 333, inclusion
333	Northern Red Oak	Quercus rubra	23.8	р	g	g	4.0	Remove	share stump with 332, inclusion
334	Red Maple	Acer rubra	22.0	р	g	f	3.0	Remove	multiple stems from base (10), limited crown
335	Green Ash	Fraxinus pennsylvanica	21.5	g	g	g	2.5	Remove	
336	Green Ash	Fraxinus pennsylvanica	27.2	g	g	g	4.0	Remove	insect damage on leaves
337	Green Ash	Fraxinus pennsylvanica	25.7	g	g	g	4.0	Remove	insect damage on leaves
338	Northern Red Oak	Quercus rubra	32.3	р	g	g	5.5	Remove	shared stump with 339 and 340 inclusion wood
339	Northern Red Oak	Quercus rubra	29.3	р	g	g	5.0	Remove	shared stump with 338 and 340 inclusion wood
340	Northern Red Oak	Quercus rubra	30.7	р	g	g	5.0	Remove	shared stump with 338 and 339 inclusion wood, dieback
341	Green Ash	Fraxinus pennsylvanica	24.6	g	g	g	3.0	Remove	insect damage on leaves
342	Trembling Aspen	Populus tremuloides	19.8	g	g	g	3.0	Remove	
343	Trembling Aspen	Populus tremuloides	20.0	f	g	g	3.0	Remove	inclusion in crown
344	Balsam Fir	Abies balsamea	16.3	g	g	g	2.0	Remove	
345	Green Ash	Fraxinus pennsylvanica	24.3	g	g	g	3.0	Remove	dieback
346	Red Maple	Acer rubra	23.2	l t	g	g	3.0	Remove	inclusion at base possible rot
347	White Birch	Betula papyrifera	23.8	dead				Remove	
348	White Birch	Betula papyrifera	32.7	dead			2.0	Remove	
349	Green Ash	Fraxinus pennsylvanica	17.6	ſ	g	g	3.0	Remove	twisted trunk, lean
350	Northern Red Oak	Quercus rubra	23.8	ſ	9	9	3.0	Remove	multiple stems at 4.0m, inclusion
351	Northern White Cedar	Thuja occidentalis	28.9	T	9	9	4.0	Remove	trunk wounds
352	Northern White Cedar	Thuja occidentalis	16.9	g	<u>g</u>	9	2.0 3.0	Remove	overtop suppressed
353	Northern Red Oak	Quercus rubra	16.5	g	9	g		Remove	
354	Northern White Coder	Thuja occidentalis	15.8	g	g	9	2.0	Remove	overtan cunnifered
355 356	Northern White Cedar Northern White Cedar	Thuja occidentalis Thuja occidentalis	17.5 16.2	g	g	g	2.5 2.5	Remove Remove	overtop suppressed overtop suppressed
357	Balsam Fir	Abies balsamea	24.9	dead	y	y	2.5	Remove	over top suppressed
358	Northern White Cedar	Thuja occidentalis	22.7	ueau	0	α	4.0	Remove	dieback
359	Northern Red Oak	Quercus rubra	28.0	g	g	9	5.0	Remove	dieback
360	Green Ash	Fraxinus pennsylvanica	22.2	y a	9	<u>9</u>	3.5	Remove	
361	Balsam Fir	Abies balsamea	21.5	dead	9	9	3.3	Remove	
362	Northern Red Oak	Quercus rubra	16.8	n	а	п	3.0	Remove	
363	Northern White Cedar	Thuja occidentalis	23.3	<u>9</u>	<u>9</u>	n n	3.0	Remove	
364	Red Maple	Acer rubra	29.0	y n	n n	n n	4.0	Remove	large branches, inclusion
365	Balsam Fir	Abies balsamea	19.2	n	n	n	3.0	Remove	parge stationes, morasion
366	Balsam Fir	Abies balsamea	17.2	n 9	n	n	2.0	Remove	
367	White Birch	Betula papyrifera	26.0	dead	9	9	2.0	Remove	
368	Balsam Fir	Abies balsamea	15.2	n	п	n	2.0	Remove	
300	Daisaiii fii	Avies vaisaillea	13.2	<u>y</u>	l y	J 9	Z.U	кенноче	

					Condition		Canopy Radius	Recommendation	
Tag No.	Common Name	Scientific Name	DBH (cm)	TI .	CS	CV	(m)		Comments
367	Balsam Fir	Abies balsamea	18.2	dead				Remove	
370	Red Maple	Acer rubra	24.5	dead				Remove	
371	Balsam Fir	Abies balsamea	18.2	g	g	g	2.5	Remove	
372	Red Maple	Acer rubra	19.0	р	g	g	4.0	Remove	share stump inclusion
373	Red Maple	Acer rubra	21.1	р 	g	g	4.0	Remove	share stump, inclusion
374	Balsam Fir	Abies balsamea	21.8	dead				Remove	
275	Northern White Cedar	Thuja occidentalis	22.5	р	р	р	1.0	Remove	on the ground, mostly dead
276	Green Ash	Fraxinus pennsylvanica	15.3	р	р	р	0.5	Remove	almost dead, epicormic branching, wood pecker
377	Red Maple	Acer rubra	28.1	р	р	р	1.0	Remove	mostly dead, dieback, epicormic branching
378	White Birch	Betula papyrifera	28.0	dead				Remove	
379	White Birch	Betula papyrifera	18.5	dead				Remove	
380	Green Ash	Fraxinus pennsylvanica	16.4	dead				Remove	
381	Green Ash	Fraxinus pennsylvanica	17.2	dead				Remove	
382	Green Ash	Fraxinus pennsylvanica	18.7	dead				Remove	
383	White Birch	Betula papyrifera	24.5	dead				Remove	
384	Green Ash	Fraxinus pennsylvanica	16.3	g	g	g	2.5	Remove	
385	Balsam Fir	Abies balsamea	16.4	g	g	f	2.0	Remove	sparce crown
386	Balsam Fir	Abies balsamea	17.4	f	g	f	2.5	Remove	wound at top, suppressed
387	Green Ash	Fraxinus pennsylvanica	15.2	dead				Remove	
388	White Birch	Betula papyrifera	22.5	dead				Remove	
389	Balsam Fir	Abies balsamea	20.3	р	р	р	1.0	Remove	mostly dead
390	Balsam Fir	Abies balsamea	17.5	dead				Remove	
391	Balsam Fir	Abies balsamea	17.0	g	g	g	2.5	Remove	
				J					
392	Northern White Cedar	Thuja occidentalis	16.8	р	р	р	2.0	Remove	exposed roots, trunk wound, sever lean, shared stump with 393
393	Northern White Cedar	Thuja occidentalis	19.5	р	р	р	2.5	Remove	trunk wound, sever lean
394	Red Maple	Acer rubra	17.4	q	q	q	2.5	Remove	dieback
395	Balsam Fir	Abies balsamea	26.1	f	q	q	3.0	Remove	sever lean, dieback
B2	Northern White Cedar	Thuja occidentalis	36 (estimate)	р	р	р	n/a	Remove	laying on ground with live branches, trunk wound
				'		'		Retain - Tree protection	7 0 0
В3	Northern White Cedar	Thuja occidentalis	28.5	g	q	q	2.5	fencing	sever lean, wood pecker, trunk wound
				'	'	'		Retain - Tree protection	
B4	Northern White Cedar	Thuja occidentalis	27.0	р	р	q	2.0	fencing	sever lean, trunk wound
396	Northern White Cedar	Thuja occidentalis	28.9	a	a	a	2.5	Remove	
B5	Balsam Fir	Abies balsamea	20.8	dead	3	3		Remove	
B6	Northern White Cedar	Thuja occidentalis	19.9	a	а	а	2.5	Remove	
397	Northern White Cedar	Thuja occidentalis	18.0	u a	u	u a	2.0	Remove	
398	Balsam Fir	Abies balsamea	19.9	g G	u a	u a	2.5	Remove	
300	Dalloann I II			3	3	3	1	Retain - Tree protection	
B8	Balsam Fir	Abies balsamea	20.2	n	n	n	3.0	fencing	
399	Green Ash	Fraxinus pennsylvanica	19.4	dead	9	9	3.0	Remove	
400	Green Ash	Fraxinus pennsylvanica	33.2	dead			+ +	Remove	
401	Red Maple	Acer rubra	33.0	n	f	n	3.0	Remove	dieback, shared stump with 402 and 403
402	Red Maple	Acer rubra	21.1	p p	f	n n	3.0	Remove	dieback, shared stump with 401 and 403
402	reu iviapie	ALEI TUDI A	Z 1. I	μ	l	LΡ	ა.0	кешиче	עוובשמנה, אומו פט אנעוווף שונוו אטד מווע אטא

							T		
					Conditio	on	Canopy Radius	Recommendation	
Tag No.	Common Name	Scientific Name	DBH (cm)	TI	CS	CV	(m)		Comments
403	Red Maple	Acer rubra	46.3	р	f	р	3.0	Remove	dieback, shared stump with 401 and 402, inclusion
404	White Birch	Betula papyrifera	34.5	dead				Remove	
405	White Birch	Betula papyrifera	40.0	dead				Remove	
406	White Birch	Betula papyrifera	16.5	dead				Remove	
407	Red Maple	Acer rubra	17.5	dead				Remove	
408	Red Maple	Acer rubra	16.8	р	р	р	1.5	Remove	mostly dead, shared stump with 407
409	Red Maple	Acer rubra	20.7	dead				Remove	
410	Green Ash	Fraxinus pennsylvanica	16.9	g	g	g	3.0	Remove	
411	Red Maple	Acer rubra	21.0	dead				Remove	
412	Balsam Fir	Abies balsamea	15.8	g	g	g	2.5	Remove	
413	Trembling Aspen	Populus tremuloides	19.5	g	g	g	3.0	Remove	
414	Balsam Fir	Abies balsamea	16.0	dead				Remove	
415	Red Maple	Acer rubra	17.6	dead				Remove	
416	White Birch	Betula papyrifera	19.9	dead			0.5	Remove	
417	Balsam Fir	Abies balsamea	16.2	g	g	Ť	2.5	Remove	dieback
418	Green Ash	Fraxinus pennsylvanica	40.7	dead			2.2	Remove	
419	Red Maple	Acer rubra	17.2	p	р	р	2.0	Remove	mostly dead
420	Green Ash	Fraxinus pennsylvanica	17.5	dead				Remove	
421	White Birch	Betula papyrifera	26.8	dead				Remove	
422	Balsam Fir	Abies balsamea	26.8	dead				Remove	
423	Green Ash	Fraxinus pennsylvanica	51.1	dead				Remove	
424	Green Ash	Fraxinus pennsylvanica	39.9	dead				Remove	_
425	Balsam Fir	Abies balsamea	21.2	dead				Remove	_
426	White Birch	Betula papyrifera	18.0	dead				Remove	
427	White Birch	Betula papyrifera Acer rubra	21.0	dead	<u></u>		2.5	Remove	dieback, inclusion, shared stump with 429 and 430
428	Red Maple			р	р	p		Remove	l l
429	Red Maple	Acer rubra	22.2	р	ρ	ρ	2.5	Remove	dieback, inclusion, shared stump with 428 and 430
430	Red Maple	Acer rubra	19.9	n	n	n	2.5	Remove	trunk wound, dieback, inclusion, shared stump with 428 and 429
	Balsam Fir	Abies balsamea	19.9	h	Р	þ	2.3	Remove	trunk wound, dieback, inclusion, shared stump with 426 and 429
431 432	Red Maple	Abies baisamea Acer rubra	23.4	dead	n	n	2.0	Remove	almost dead, dieback, trunk wounds, share stump with 433
432	Red Maple	Acer rubra	22.5	p	p n	p n	2.0	Remove	trunk wound, dieback, share stump with 432
434	Green Ash	Fraxinus pennsylvanica	16.5	dead	Ρ	P	2.0	Remove	trunk wound, dieback, share stump with 452
434	Green Ash	Fraxinus pennsylvanica	15.6	n	n	n	1.0	Remove	mostly dead, dieback, multiple stems at 4.0m, inclusion
436	Green Ash	Fraxinus pennsylvanica	18.7	dead	Ρ	ρ	1.0	Remove	mostry dead, dieback, multiple stems at 4.0m, inclusion
436	Green Ash	Fraxinus pennsylvanica	20.7	dead			+	Remove	
437	Green Ash	Fraxinus pennsylvanica	16.9	dead			+	Remove	
439	Green Ash	Fraxinus pennsylvanica	16.0	n	П	а	3.0	Remove	dieback
440	Green Ash	Fraxinus pennsylvanica	18.2	<u>9</u>	<u>9</u>	<u>9</u>	2.5	Remove	dieback
441	Red Maple	Acer rubra	19.0	n n	<u>9</u>	<u>9</u>	2.5	Remove	trunk inclusion
442	Green Ash	Fraxinus pennsylvanica	16.9	n	n 9	f g	2.5	Remove	dieback, epicormic branching
443	Green Ash	Fraxinus pennsylvanica	15.3	n 9	n n	n	2.0	Remove	dieback, epicormic branching
444	Northern Red Oak	Quercus rubra	19.2	u 9	g	<u>п</u>	5.0	Remove	a.o.a.o., opioorimo aranoming
445	Northern Red Oak	Quercus rubra	25.9	u 8	g 0	u a	4.0	Remove	dieback
	Two them ned Oak	Zuci cus rubi a	20.7	У	9	<u> </u>	٠.٦	Kernove	wio buoit

				I					
					Conditio	nn	Canopy Radius	Recommendation	
Tag No.	Common Name	Scientific Name	DBH (cm)	TI	CS	CV	(m)	Recommendation	Comments
446	Green Ash	Fraxinus pennsylvanica	19.8	a	a	a	3.0	Remove	Soliminsto
447	Northern Red Oak	Quercus rubra	27.0	a	a	a	5.0	Remove	
448	White Birch	Betula papyrifera	24.0	dead				Remove	
449	Northern White Cedar	Thuja occidentalis	25.0	р	q	q	2.0	Remove	wood pecker
450	Green Ash	Fraxinus pennsylvanica	16.0	f	f	f	3.0	Remove	dieback, epicormic branching
451	White Birch	Betula papyrifera	29.0	dead				Remove	
452	Red Maple	Acer rubra	32.5	g	g	g	5.0	Remove	
453	Northern White Cedar	Thuja occidentalis	19.9	g	g	g	3.0	Remove	
454	Green Ash	Fraxinus pennsylvanica	15.2	dead				Remove	
455	White Birch	Betula papyrifera	18.2	dead				Remove	
456	Northern White Cedar	Thuja occidentalis	21.3	g	g	g	2.0	Remove	
457	Green Ash	Fraxinus pennsylvanica	25.1	g	g	g	4.0	Remove	
								Retain - Tree protection	
458	Green Ash	Fraxinus pennsylvanica	15.9	g	g	f	2.5	fencing	dieback
								Retain - Tree protection	
459	Northern Red Oak	Quercus rubra	25.0	g	g	g	4.0	fencing	
								Retain - Tree protection	
460	White Birch	Betula papyrifera	16.8	р	g	g	2.5	fencing	sever lean
								Retain - Tree protection	
461	Red Maple	Acer rubra	32.8	р	g	g	5.0	fencing	seam trunk inclusion
	5							Retain - Tree protection	
462	Red Maple	Acer rubra	24.8	g	g	g	2.0	fencing	
400	DI LOI	D	00.0				4.0	Retain - Tree protection	
463	Black Cherry	Prunus serotina	20.8	g	g	g	4.0	fencing	
404	Croon Ash	Fravinus nannavlvanias	10.0	dood				Retain - Tree protection	
464	Green Ash	Fraxinus pennsylvanica	19.0	dead				fencing Retain - Tree protection	
465	Northern White Cedar	Thuja occidentalis	17.0	dead				fencing	
465	Northern write cedar	Thuja occidentalis	17.0	ueau				Retain - Tree protection	
466	Northern White Cedar	Thuja occidentalis	34.0	n	a	а	2.5	fencing	trunk wound. shared stump with 465
400	Northern write cedar	Thuja occidentalis	34.0	Р	y	y	2.5	Retain - Tree protection	trank wound. Shared Stamp with 403
467	Green Ash	Fraxinus pennsylvanica	21.0	dead				fencing	
407	Greenvish	Traxinas perinsylvanica	21.0	acaa				Retain - Tree protection	
468	Trembling Aspen	Populus tremuloides	27.2	a	a	а	4.0	fencing	insect damage on leaves
.55		, oparae a emaretae		9	9	9		Retain - Tree protection	moost damage on loares
469	White Birch	Betula papyrifera	29.0	g	a	a	3.5	fencing	trunk wound, insect damage on leaves
		1 13		'				Retain - Tree protection	·
470	Red Maple	Acer rubra	25.5	р	р	р	3.0	fencing	mostly dead, shared stump with 471, trunk wound
471	Red Maple	Acer rubra	21.0	p	f	f	4.0	Remove	mostly dead, shared stump with 470, trunk wound, dieback
	·							Retain - Tree protection	·
472	Red Maple	Acer rubra	23.9	dead				fencing	
								Retain - Tree protection	
473	Northern White Cedar	Thuja occidentalis	21.5	р	g	g	2.5	fencing	extensive trunk wound

					Conditio	on	Canopy Radius	Recommendation	
Tag No.	Common Name	Scientific Name	DBH (cm)	TI	CS	CV	(m)		Comments
								Retain - Tree protection	
474	White Birch	Betula papyrifera	25.0	g	g	f	3.0	fencing	dieback
475	Green Ash	Fraxinus pennsylvanica	17.2	g	g	g	3.0	Remove	
476	Balsam Fir	Abies balsamea	15.5	р	Ť	<u>†</u>	2.0	Remove	trunk wound, dieback, overtop suppressed
477	Northern White Cedar	Thuja occidentalis	27.5	g	g	g	2.0	Remove	lean
478 479	Green Ash Northern Red Oak	Fraxinus pennsylvanica	15.1 17.2	<u>g</u>	g	9	3.0 4.0	Remove	
	Northern White Cedar	Quercus rubra	32.0	g	g	g	2.5	Remove	loan
480	Northern white cedar	Thuja occidentalis	32.0	g	y	y	2.5	Remove Retain - Tree protection	lean
481	Balsam Fir	Abies balsamea	18.0		a	a	2.5	fencing	
401	Balsaili Fil	ADIES Daisainea	16.0	y	y	y	2.5	Retain - Tree protection	
482	Northern White Cedar	Thuja occidentalis	31.2	f	a	n	4.0	fencing	lean
483	Northern White Cedar	Thuja occidentalis	17.1	u u	g	n	2.0	Remove	ican
400	Worthern Write cedar	maja occidentalis	17.1	9	9	9	2.0	Retain - Tree protection	
484	White Birch	Betula papyrifera	39.0	dead				fencing	
	William Billion	Botala papymora	37.3	чочч				Retain - Tree protection	
485	Red Maple	Acer rubra	27.9	f	a	a	4.0	fencing	trunk abrasions
					3	3		Retain - Tree protection	
486	Northern White Cedar	Thuja occidentalis	27.8	f	q	a	2.5	fencing	trunk wounds
487	Red Maple	Acer rubra	33.0	р	q	q	4.5	Remove	rotten stump attached at base
488	Red Maple	Acer rubra	25.2	q	q	f	3.0	Remove	dieback
489	Green Ash	Fraxinus pennsylvanica	17.7	g	g	g	3.0	Remove	
490	Green Ash	Fraxinus pennsylvanica	18.0	g	g	g	3.0	Remove	
491	Northern White Cedar	Thuja occidentalis	16.9	р	р	р	2.0	Remove	trunk wound, dieback
492	Northern White Cedar	Thuja occidentalis	26.1	р	f	f	2.0	Remove	seam, trunk wound, dieback
493	White Birch	Betula papyrifera	33.0	dead				Remove	
494	White Birch	Betula papyrifera	20.5	dead				Remove	
495	Red Maple	Acer rubra	19.1	g	g	g	3.0	Remove	
496	Red Maple	Acer rubra	31.5	f	f	f	3.0	Remove	trunk wound, dieback
497	Green Ash	Fraxinus pennsylvanica	19.5	g	g	g	3.0	Remove	
498	Red Maple	Acer rubra	21.5	dead				Remove	
499	White Birch	Betula papyrifera	19.5	р	р	р	3.0	Remove	sever lean, trunk wound, dieback
			25.5		_	_		Retain - Tree protection	
500	Green Ash	Fraxinus pennsylvanica	22.0	р	f	f	3.0	fencing	trunk wound
501	Green Ash	Fraxinus pennsylvanica	16.5	р	р	р	0.5	Remove	all dead except for epicormic branching
502	Green Ash	Fraxinus pennsylvanica	22.6	dead			-	Remove	
503	Green Ash	Fraxinus pennsylvanica	23.5	dead				Remove	
504	Green Ash	Fraxinus pennsylvanica	18.8	dead			1.0	Remove	broken top, all dood event for an income in the control of
505	Green Ash	Fraxinus pennsylvanica	24.7	p	p	p	1.0	Remove	broken top, all dead except for epicormic branching
506	Green Ash	Fraxinus pennsylvanica	23.4	b	р	р	1.0	Remove	all dead except one branch
507	Green Ash	Fraxinus pennsylvanica	17.2	dead			1.0	Remove	all doad except one branch
508	Green Ash	Fraxinus pennsylvanica	17.5 27.5	dead	р	р	1.0	Remove	all dead except one branch
509	Trembling Aspen	Populus tremuloides		ueau	f	f	4.0	Remove	dioback Jargo branchos
510	Trembling Aspen	Populus tremuloides	26.3	<u>y</u>			4.0	Remove	dieback, large branches

							T		
					Conditio	on	Canopy Radius	Recommendation	
Tag No.	Common Name	Scientific Name	DBH (cm)	TI	CS	CV	(m)		Comments
511	Red Maple	Acer rubra	15.8	dead				Remove	
512	Northern Red Oak	Quercus rubra	25.0	g	g	f	5.0	Remove	dieback
513	Trembling Aspen	Populus tremuloides	23.3	dead				Remove	
514	Trembling Aspen	Populus tremuloides	21.5	g	g	g	3.0	Remove	
515	Trembling Aspen	Populus tremuloides	18.0	g	g	g	3.0	Remove	
516	Bigtooth Aspen	Populus grandidentata	18.7	dead				Remove	
517	Bigtooth Aspen	Populus grandidentata	18.2	dead				Remove	
518	Trembling Aspen	Populus tremuloides	16.2	g	g	g	2.0	Remove	
519	Trembling Aspen	Populus tremuloides	25.2	g	g	g	3.0	Remove	
520	Trembling Aspen	Populus tremuloides	20.3	g	g	g	3.0	Remove	dieback
	-		44.0					Retain - Tree protection	
521	Trembling Aspen	Populus tremuloides	16.2	dead			1	fencing	
	5 114		45.0					Retain - Tree protection	
522	Red Maple	Acer rubra	15.8	g	g	f	3.0	fencing	dieback, red leaves
523	Green Ash	Fraxinus pennsylvanica	21.5	f	Ť	Ť	3.0	Remove	sparce foliage, EAB
524	Bigtooth Aspen	Populus grandidentata	29.3	Т	g	g	5.0	Remove	base trunk wound
525	Willow Species	Salix sp.	24.0	р	g	g	5.0	Remove	shared stump with 526,527,529, inclusion
526	Willow Species	Salix sp.	23.5	р	g	g		Remove	sever lean, shared stump with 525,527,529, inclusion
507	Willow Chasica	Calivan	24.1		£		4.0	Domovo	sover lean chared stump with F2F F2/ F20 inclusion large branches
527	Willow Species	Salix sp. Salix sp.	34.1 30.2	р	<u>u</u>	g	4.0	Remove Remove	sever lean, shared stump with 525,526,529, inclusion, large branches sever lean, shared stump with 525, 526,527, inclusion
528 529	Willow Species Trembling Aspen	Populus tremuloides	18.9	р	g	g	4.0	Remove	sever learr, shared sturnp with 525, 526,527, inclusion
530	Trembling Aspen	Populus tremuloides Populus tremuloides	15.9	g	g	g	3.0	Remove	
531	Northern Red Oak	Quercus rubra	16.5	f f	g f	f f	4.0	Remove	dieback, branch union
532	Red Maple	Acer rubra	43.2	n	ď	ď	5.0	Remove	seam, trunk wound, shared stump with 533
533	Red Maple	Acer rubra	32.5	n P	9 0	g 0	5.0	Remove	shared stump with 532, crown branch unions
534	Green Ash	Fraxinus pennsylvanica	17.7	dead	9	9	0.0	Remove	Shared stamp with 552, Grown Brahen amons
535	Green Ash	Fraxinus pennsylvanica	18.5	n	а	f	3.0	Remove	dieback
536	Red Maple	Acer rubra	24.5	a	a	f	4.0	Remove	dieback
537	Red Maple	Acer rubra	17.2	n D	n D	a	3.0	Remove	trunk wound, number of branch unions @4.0m
538	Trembling Aspen	Populus tremuloides	20.0	a	a	f	3.0	Remove	dieback
539	Trembling Aspen	Populus tremuloides	21.1	q	q	q	3.0	Remove	
540	White Birch	Betula papyrifera	24.5	dead		<u> </u>	†	Remove	
541	Green Ash	Fraxinus pennsylvanica	30.0	dead				Remove	
542	Green Ash	Fraxinus pennsylvanica	15.8	q	q	р	3.0	Remove	epicormic branching, sparce foliage
543	White Birch	Betula papyrifera	33.8	dead	Ĭ		1	Remove	
544	Green Ash	Fraxinus pennsylvanica	18.0	g	g	р	3.0	Remove	dieback, epicormic branching, sparce foliage
545	Red Maple	Acer rubra	15.2	g	g	g	3.0	Remove	
546	Trembling Aspen	Populus tremuloides	15.2	р	f	р	2.0	Remove	dieback, sparce foliage, branch spikes
547	Green Ash	Fraxinus pennsylvanica	16.3	dead				Remove	
548	Green Ash	Fraxinus pennsylvanica	19.2	dead				Remove	
549	Green Ash	Fraxinus pennsylvanica	27.9	f	f	f	3.0	Remove	sparce foliage, dieback, trunk wound
550	White Birch	Betula papyrifera	24.0	dead				Remove	
551	Green Ash	Fraxinus pennsylvanica	16.1	g	f	р	1.0	Remove	heavy dieback, epicormic branching, dead top

					Conditio		Canopy Radius	Recommendation	
Tag No.	Common Name	Scientific Name	DBH (cm)	TI	CS	CV	(m)		Comments
552	Green Ash	Fraxinus pennsylvanica	15.1	dead				Remove	
553	Red Maple	Acer rubra	46.5	р	р	р	4.0	Remove	heavy dieback, trunk seam, inclusion
554	White Birch	Betula papyrifera	21.4	dead				Remove	
555	Balsam Fir	Abies balsamea	16.0	dead				Remove	
556	Red Maple	Acer rubra	20.8	g	g	f	4.0	Remove	dieback
557	White Birch	Betula papyrifera	26.8	g	g	g	4.5	Remove	
558	White Birch	Betula papyrifera	22.8	р	g	g	2.5	Remove	base inclusions, shared stump, wood pecker holes
	White Birch	Betula papyrifera	17.0	р	g	g	2.5	Remove	
559	White Birch	Betula papyrifera	17.5	р	g	g	3.0	Remove	sever lean
560	Green Ash	Fraxinus pennsylvanica	17.7	g	f	р	3.0	Remove	db
561	White Birch	Betula papyrifera	25.2	dead				Remove	
562	Eastern Hemlock	Tsuga canadensis	28.7	g	g	g	4.5	Remove	sap sucker
563	Northern White Cedar	Thuja occidentalis	24.0	g	g	g	2.5	Remove	
564	Red Maple	Acer rubra	27.0	р	g	f	3.5	Remove	trunk wound, dieback
	Red Maple	Acer rubra	16.5	р	g	g	3.0	Remove	shared stump, inclusion
	Red Maple	Acer rubra	15.5	р	g	g	3.0	Remove	shared stump, inclusion
	Red Maple	Acer rubra	17.5	р	g	g	3.0	Remove	shared stump, inclusion
565	Northern White Cedar	Thuja occidentalis	25.5	g	g	g	2.5	Remove	
567	Green Ash	Fraxinus pennsylvanica	16.5	g	g	g	3.0	Remove	
568	Trembling Aspen	Populus tremuloides	15.9	g	g	g	3.0	Remove	
569	Green Ash	Fraxinus pennsylvanica	16.9	g	f	р	3.0	Remove	dieback
570	Green Ash	Fraxinus pennsylvanica	21.0	g	f	р	3.0	Remove	dieback
571	Green Ash	Fraxinus pennsylvanica	17.0	g	f	р	3.0	Remove	dieback
572	Green Ash	Fraxinus pennsylvanica	15.2	g	g	g	3.0	Remove	
573	Green Ash	Fraxinus pennsylvanica	15.2	g	g	g	2.5	Remove	
574	Balsam Fir	Abies balsamea	20.5	g	g	g	2.5	Remove	
275	Red Maple	Acer rubra	20.0	р	р	f	1.0	Remove	mostly dead
576	Red Maple	Acer rubra	20.7	р	р	f	2.0	Remove	union at base, dieback, large broken branches
577	Northern White Cedar	Thuja occidentalis	17.3	р	р	р	2.0	Remove	large trunk wound, dieback
578	Green Ash	Fraxinus pennsylvanica	19.2	g	g	g	3.0	Remove	
579	Green Ash	Fraxinus pennsylvanica	19.0	g	g	g	3.0	Remove	
580	White Birch	Betula papyrifera	15.2	g	g	g	2.5	Remove	
581	Green Ash	Fraxinus pennsylvanica	22.6	g	f	р	3.0	Remove	dieback
582	Northern Red Oak	Quercus rubra	30.2	g	g	f	5.0	Remove	dieback
583	Northern Red Oak	Quercus rubra	27.6	g	g	f	5.0	Remove	dieback
584	Green Ash	Fraxinus pennsylvanica	18.1	dead				Remove	
585	Green Ash	Fraxinus pennsylvanica	18.1	f	f	р	2.0	Remove	dieback, wood pecker, EAB
586	Green Ash	Fraxinus pennsylvanica	21.0	dead				Remove	
								Retain-Tree protection	
В9	Balsam Fir	Abies balsamea	20.5	g	g	g	2.5	fencing	
B10	Trembling Aspen	Populus tremuloides	16.1	dead		<u> </u>		<u> </u>	

Appendix 2. Proposed Development Plan



RIVERWOODS HOMES

RIVER ROAD WEST WASAGA BEACH



This drawing is provided by and is the property of AND Architecture Inc.. The contractor must verify all dimensions and conditions on site and must notify AND Architecture Inc. of any variations from the supplied information. This drawing is not to be scaled. The architect is not responsible for other consultants' information shown on this drawing. Refer to the appropriate consultants' adrawings before proceeding with the work. Construction must conform to all applicable codes and requirements of authorities having jurisdiction. The contractor working from drawings not specifically marked 'For Construction' must assume full responsibility and bear costs for any corrections or damages resulting from his work.

3	SEPT. 1/22	REISSUED FOR SPA	HW
2	MAR 22/22	REISSUED FOR SPA	HW
1	AUG 26/20	ISSUED FOR SPA	HW
No.	Date:	Issued/Revision:	Ву



AND Architecture Inc.
3950 14th Ave. Suite 609
Markham, ON L3R 0A9
T: 905-604-6960
E: info@andarchitectureinc.com
www.andarchitectureinc.com

Project :

RIVERWOODS HOMES

RIVER ROAD WEST WASAGA BEACH, ON


Drawing Name :

COVER

Date	JUNE 2019	Project No :	18026
Scale :			
Drawn by :	Author	Drawing No :	A 0
Checked by	Checker		A0
			<u> </u>



This drawing is provided by and is the property of AND Architecture Inc.. The contractor must verify all dimensions and conditions on site and must notify AND Architecture Inc. of any variations from the supplied information. This drawing is not to be scaled. The architect is not responsible for other consultants' information shown on this drawing. Refer to the appropriate consultants' arawings before proceeding with the work. Construction must conform to all applicable codes and requirements of authorities having jurisdiction. The contractor working from drawings not specifically marked 'For Construction' must assume full responsibility and bear costs for any corrections or damages resulting from his work.

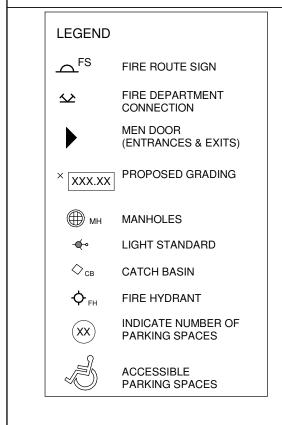

9	SEPT. 1/22	REISSUED FOR SPA	HW
8	MAR 22/22	REISSUED FOR SPA	HW
7	OCT 20/21	ISSUED FOR REVIEW	HW
6	NOV 23/20	REISSUED FOR SPA	HW
5	AUG 26/20	ISSUED FOR SPA	HW
4	MAY 06/20	ISSUED FOR REVIEW	HW
3	APR. 08/20	ISSUED FOR REVIEW	HW
2	AUG. 08/18	ISSUED FOR REVIEW	HW
1	AUG. 03/18	ISSUED FOR REVIEW	HW
No.	Date:	Issued/Revision:	Ву
		· · · · · · · · · · · · · · · · · · ·	



3950 14th Ave. Suite 609
Markham, ON L3R 0A9
T: 905-604-6960
E: info@andarchitectureinc.com

www.andarchitectureinc.com

Project :


RIVERWOODS HOMES

RIVER ROAD WEST WASAGA BEACH, ON

Drawing Name :

SITE PLAN

Date J	UNE 2019	Project No :	18026
Scale :	indicated		
Drawn by :	JW	Drawing No :	
Checked by :	HW		A1

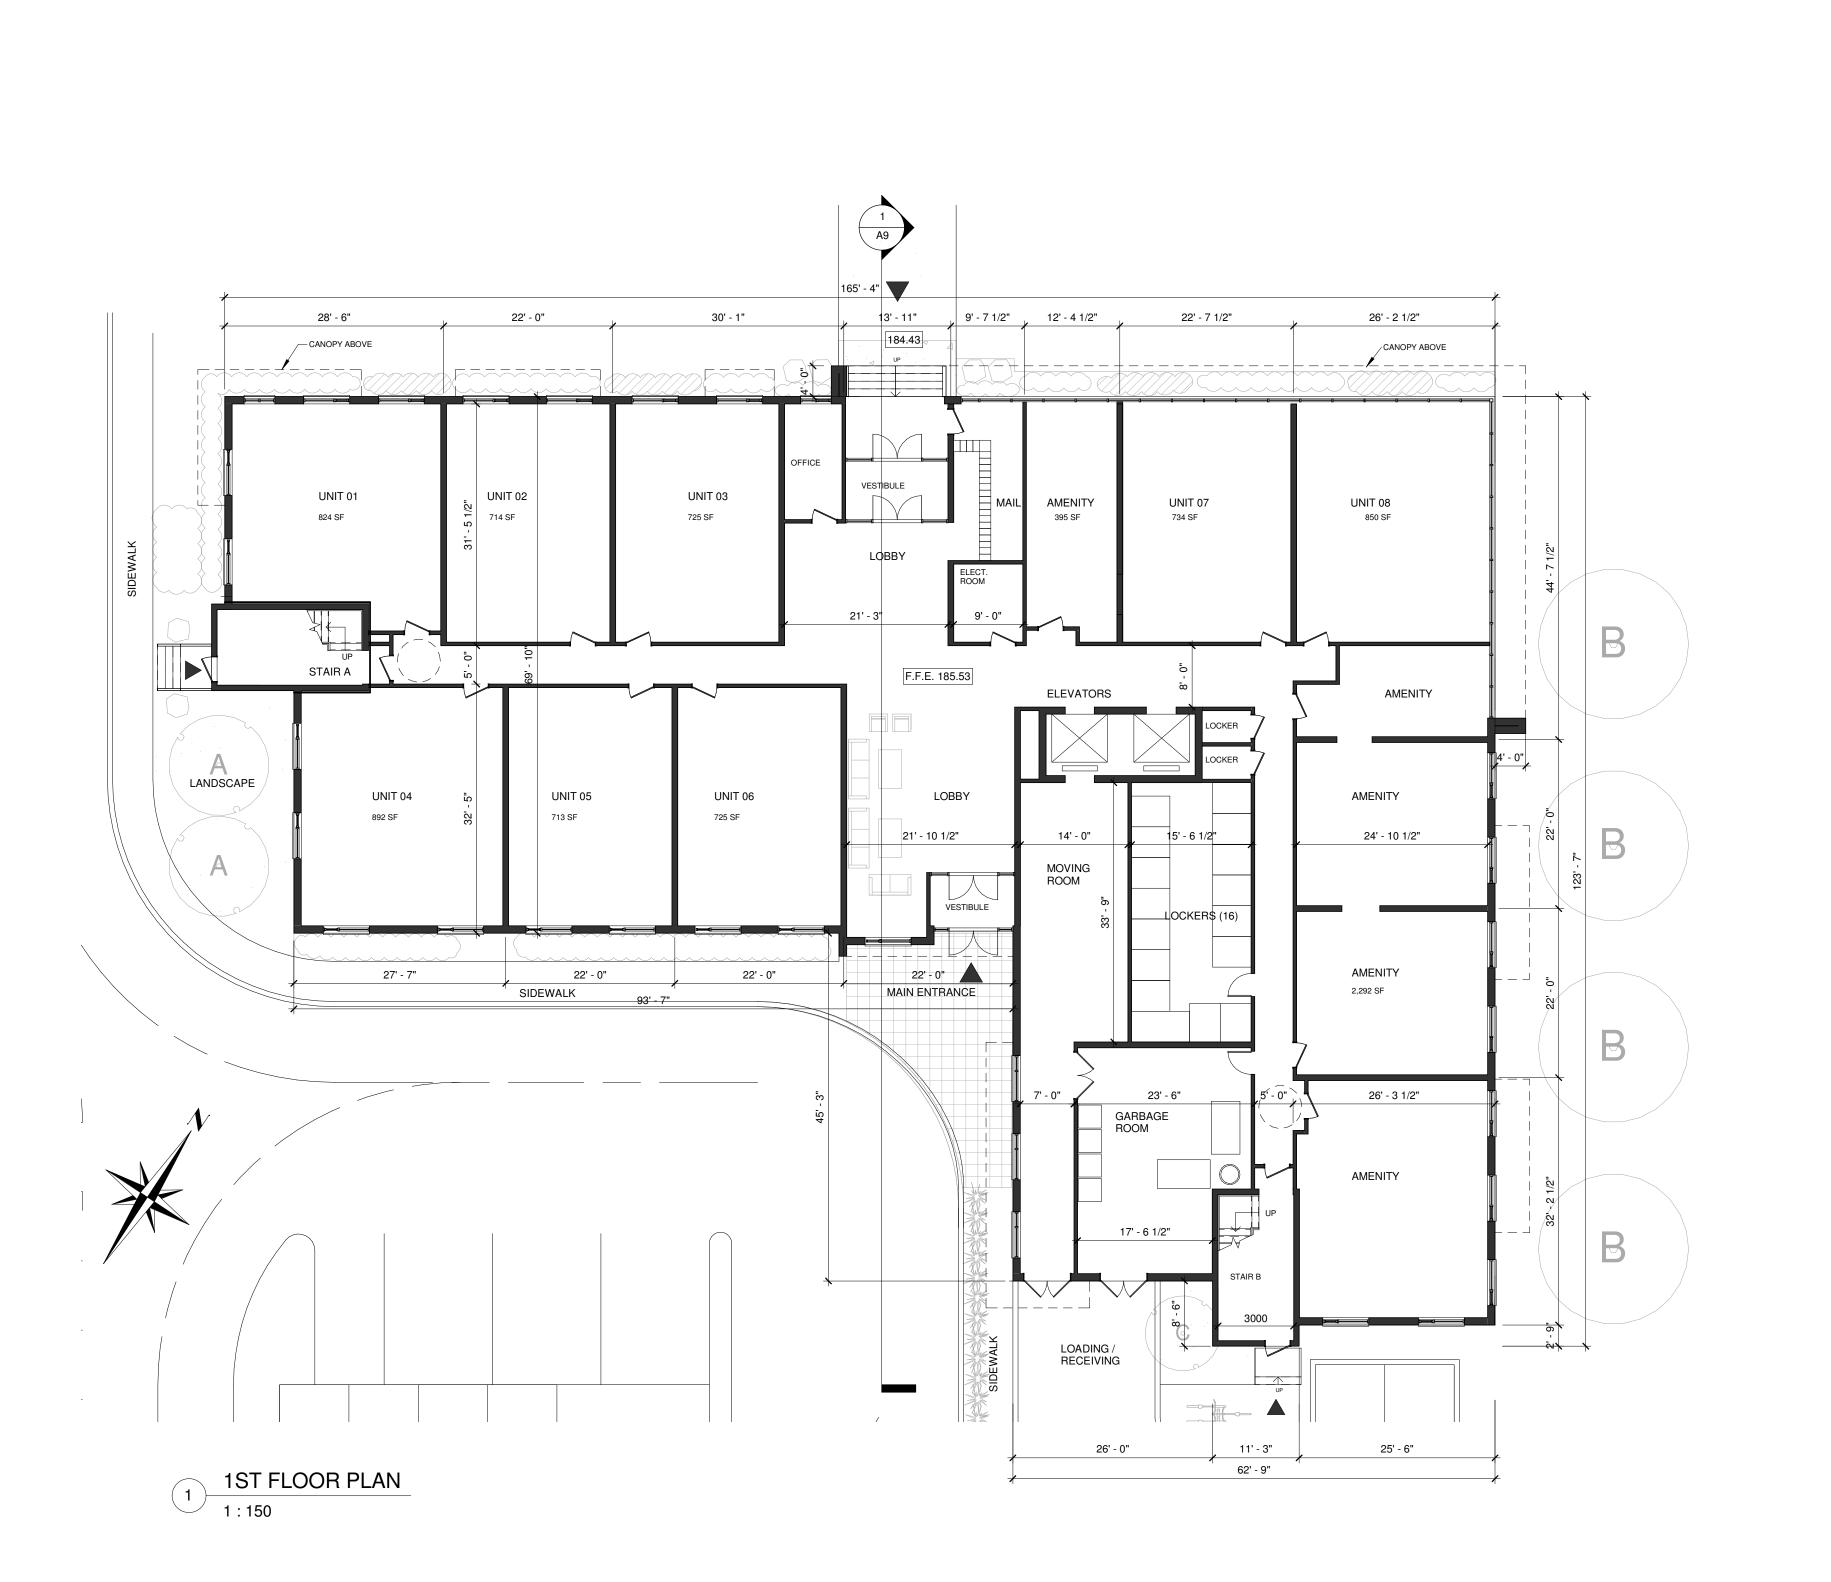

This drawing is provided by and is the property of AND Architecture Inc.. The contractor must verify all dimensions and conditions on site and must notify AND Architecture Inc. of any variations from the supplied information. This drawing is not to be scaled. The architect is not responsible for other consultants information shown on this drawing. Refer to the appropriate consultant's drawings before proceeding with the work. Construction must conform to all applicable codes and requirements of authorities having jurisdiction. The contractor working from drawings not specifically marked 'For Construction' must assume full responsibility and bear costs for any corrections or damages resulting from his work.

5	SEPT. 1/22	REISSUED FOR SPA	HW
4	MAR 22/22	REISSUED FOR SPA	HW
3	AUG 26/20	ISSUED FOR SPA	HW
2	MAY 06/20	ISSUED FOR REVIEW	HW
1	APR. 08/20	ISSUED FOR REVIEW	HW
No.	Date:	Issued/Revision:	Вv



3950 14th Ave. Suite 609
Markham, ON L3R 0A9
T: 905-604-6960
E: info@andarchitectureinc.com
www.andarchitectureinc.com

Project :


RIVERWOODS HOMES

RIVER ROAD WEST WASAGA BEACH, ON

Drawing Name :

1ST FLOOR PLAN

Date	JUNE 2019	Project No :	18026
Scale :	1:150		
Drawn by :	Author	Drawing No :	A O
Checked by	' Checker		A2

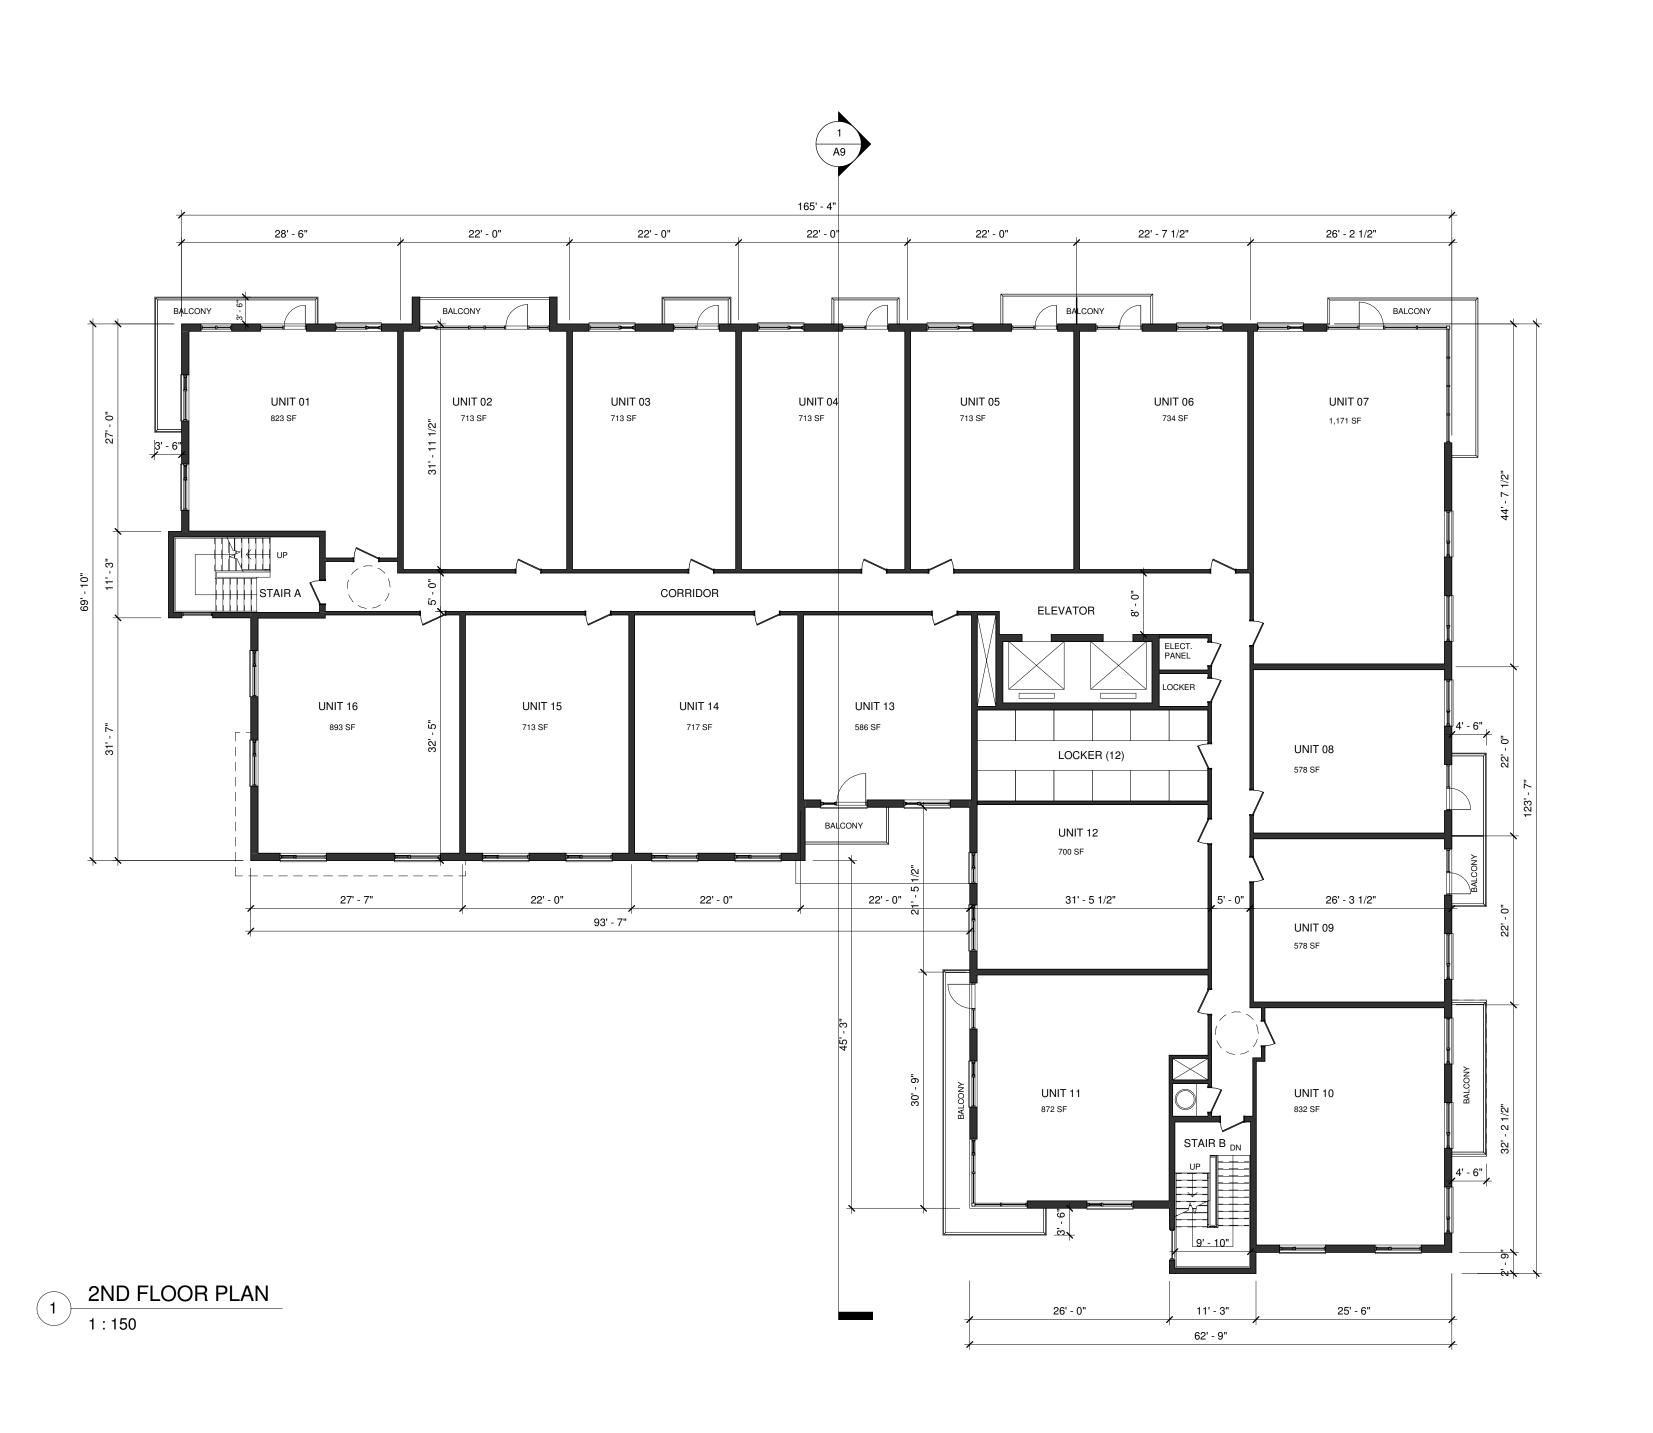

This drawing is provided by and is the property of AND Architecture Inc.. The contractor must verify all dimensions and conditions on site and must notify AND Architecture Inc. of any variations from the supplied information. This drawing is not to be scaled. The architect is not responsible for other consultants' information shown on this drawing. Refer to the appropriate consultant's drawings before proceeding with the work. Construction must conform to all applicable codes and requirements of authorities having jurisdiction. The contractor working from drawings not specifically marked 'For Construction' must assume full responsibility and bear costs for any corrections or damages resulting from his work.

5	SEPT. 1/22	REISSUED FOR SPA	HV
4	MAR 22/22	REISSUED FOR SPA	Н۷
3	AUG 26/20	ISSUED FOR SPA	Н۷
2	MAY 06/20	ISSUED FOR REVIEW	Н۷
1	APR. 08/20	ISSUED FOR REVIEW	Н۷
No.	Date:	Issued/Revision:	Ву



AND Architecture Inc. 3950 14th Ave. Suite 609 Markham, ON L3R 0A9 T: 905-604-6960 E: info@andarchitectureinc.com www.andarchitectureinc.com

Project :


RIVERWOODS HOMES

RIVER ROAD WEST WASAGA BEACH, ON

Drawing Name :

2ND FLOOR PLAN

Date	JUNE 2019	Project No :	18026
Scale :	1:150		
Drawn by :	Author	Drawing No :	10
Checked by	Checker		A3

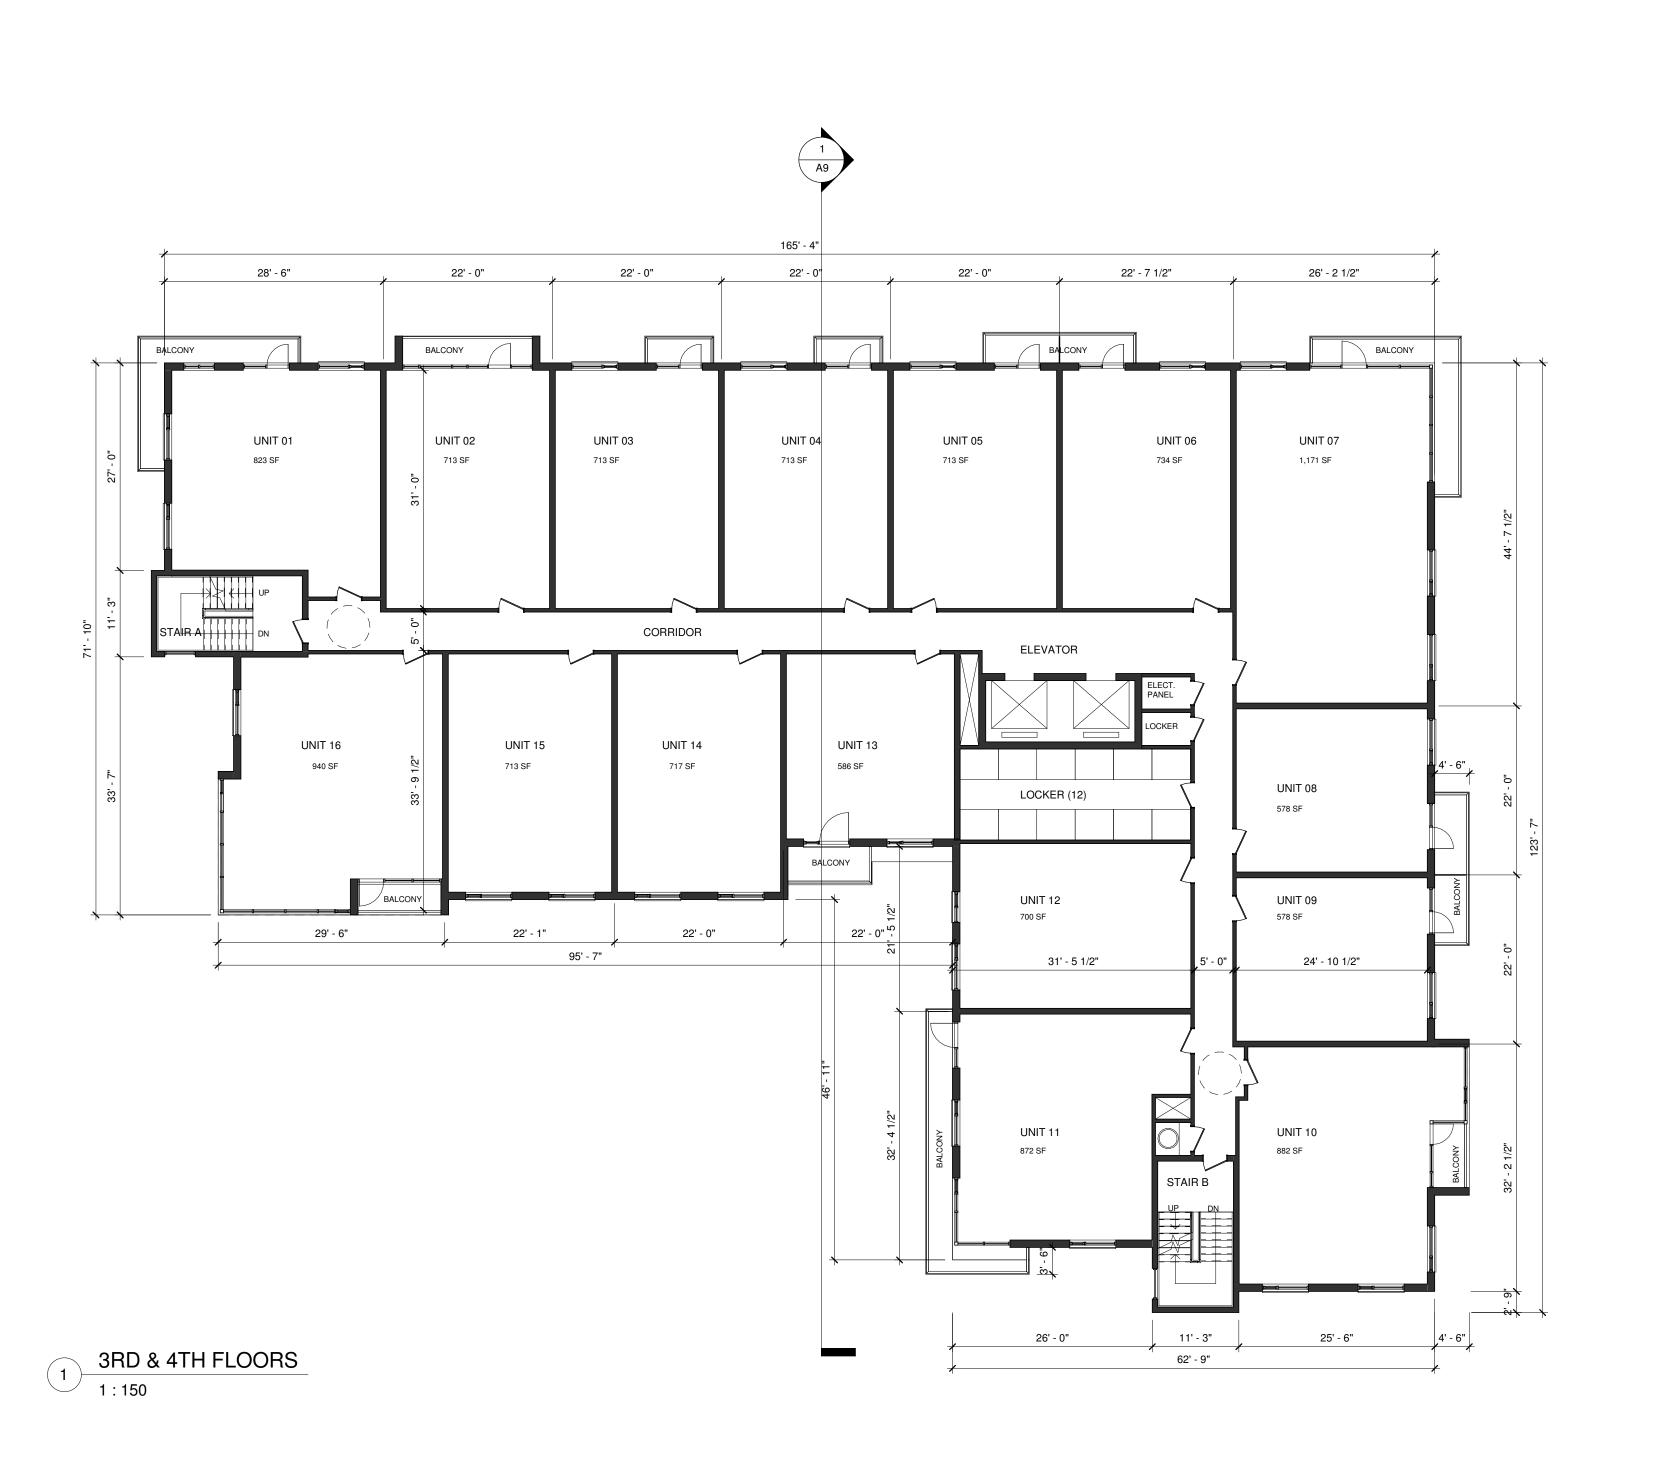

This drawing is provided by and is the property of AND Architecture Inc.. The contractor must verify all dimensions and conditions on site and must notify AND Architecture Inc. of any variations from the supplied information. This drawing is not to be scaled. The architect is not responsible for other consultants' information shown on this drawing. Refer to the appropriate consultant's drawings before proceeding with the work. Construction must conform to all applicable codes and requirements of authorities having jurisdiction. The contractor working from drawings not specifically marked 'For Construction' must assume full responsibility and bear costs for any corrections or damages resulting from his work.

5	SEPT. 1/22	REISSUED FOR SPA	Н٧
4	MAR 22/22	REISSUED FOR SPA	Н۷
3	AUG 26/20	ISSUED FOR SPA	Н۷
2	MAY 06/20	ISSUED FOR REVIEW	Н۷
1	APR. 08/20	ISSUED FOR REVIEW	Н۷
No.	Date:	Issued/Revision:	Ву



Markham, ON L3R 0A9
T: 905-604-6960
E: info@andarchitectureinc.com
www.andarchitectureinc.com

www.andarchitectureinc.com

Project :


RIVERWOODS HOMES

RIVER ROAD WEST WASAGA BEACH, ON

Drawing Name :

3RD & 4TH FLOORS

Date	JUNE 2019	Project No :	18026
Scale :	1:150		
Drawn by :	Author	Drawing No :	
Checked by	Checker		A4
	Checker		

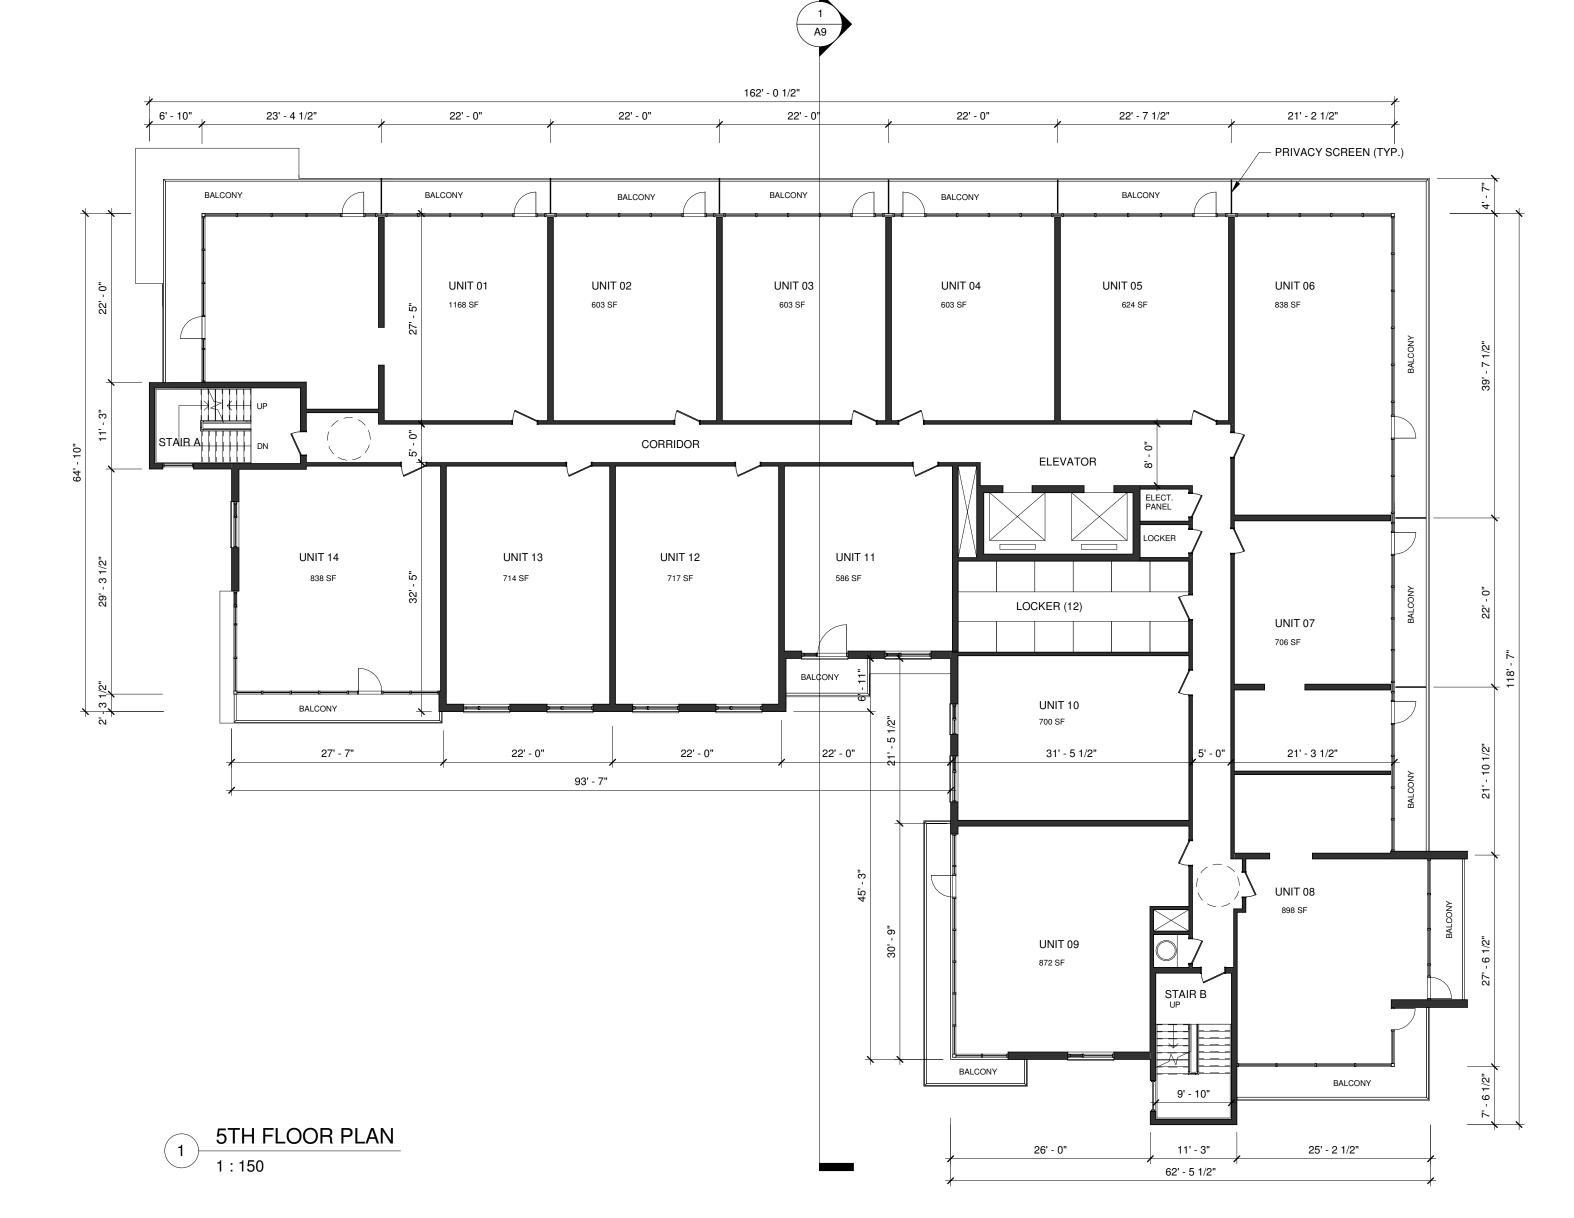

6	SEPT. 1/22	REISSUED FOR SPA	НΜ
5	MAR 22/22	REISSUED FOR SPA	НΜ
4	NOV 23/20	REISSUED FOR SPA	НΜ
3	AUG 26/20	ISSUED FOR SPA	НΜ
2	MAY 06/20	ISSUED FOR REVIEW	НΜ
1	APR. 08/20	ISSUED FOR REVIEW	НΜ
No.	Date:	Issued/Revision:	Ву



AND Architecture Inc. 3950 14th Ave. Suite 609 Markham, ON L3R 0A9 T: 905-604-6960 E: info@andarchitectureinc.com www.andarchitectureinc.com

Project :


RIVERWOODS HOMES

RIVER ROAD WEST WASAGA BEACH, ON

Drawing Name :

5TH FLOOR PLAN

Date	JUNE 2019	Project No :	18026
Scale :	1:150		
Drawn by :	Author	Drawing No :	. –
Checked by	Checker		A5
•			

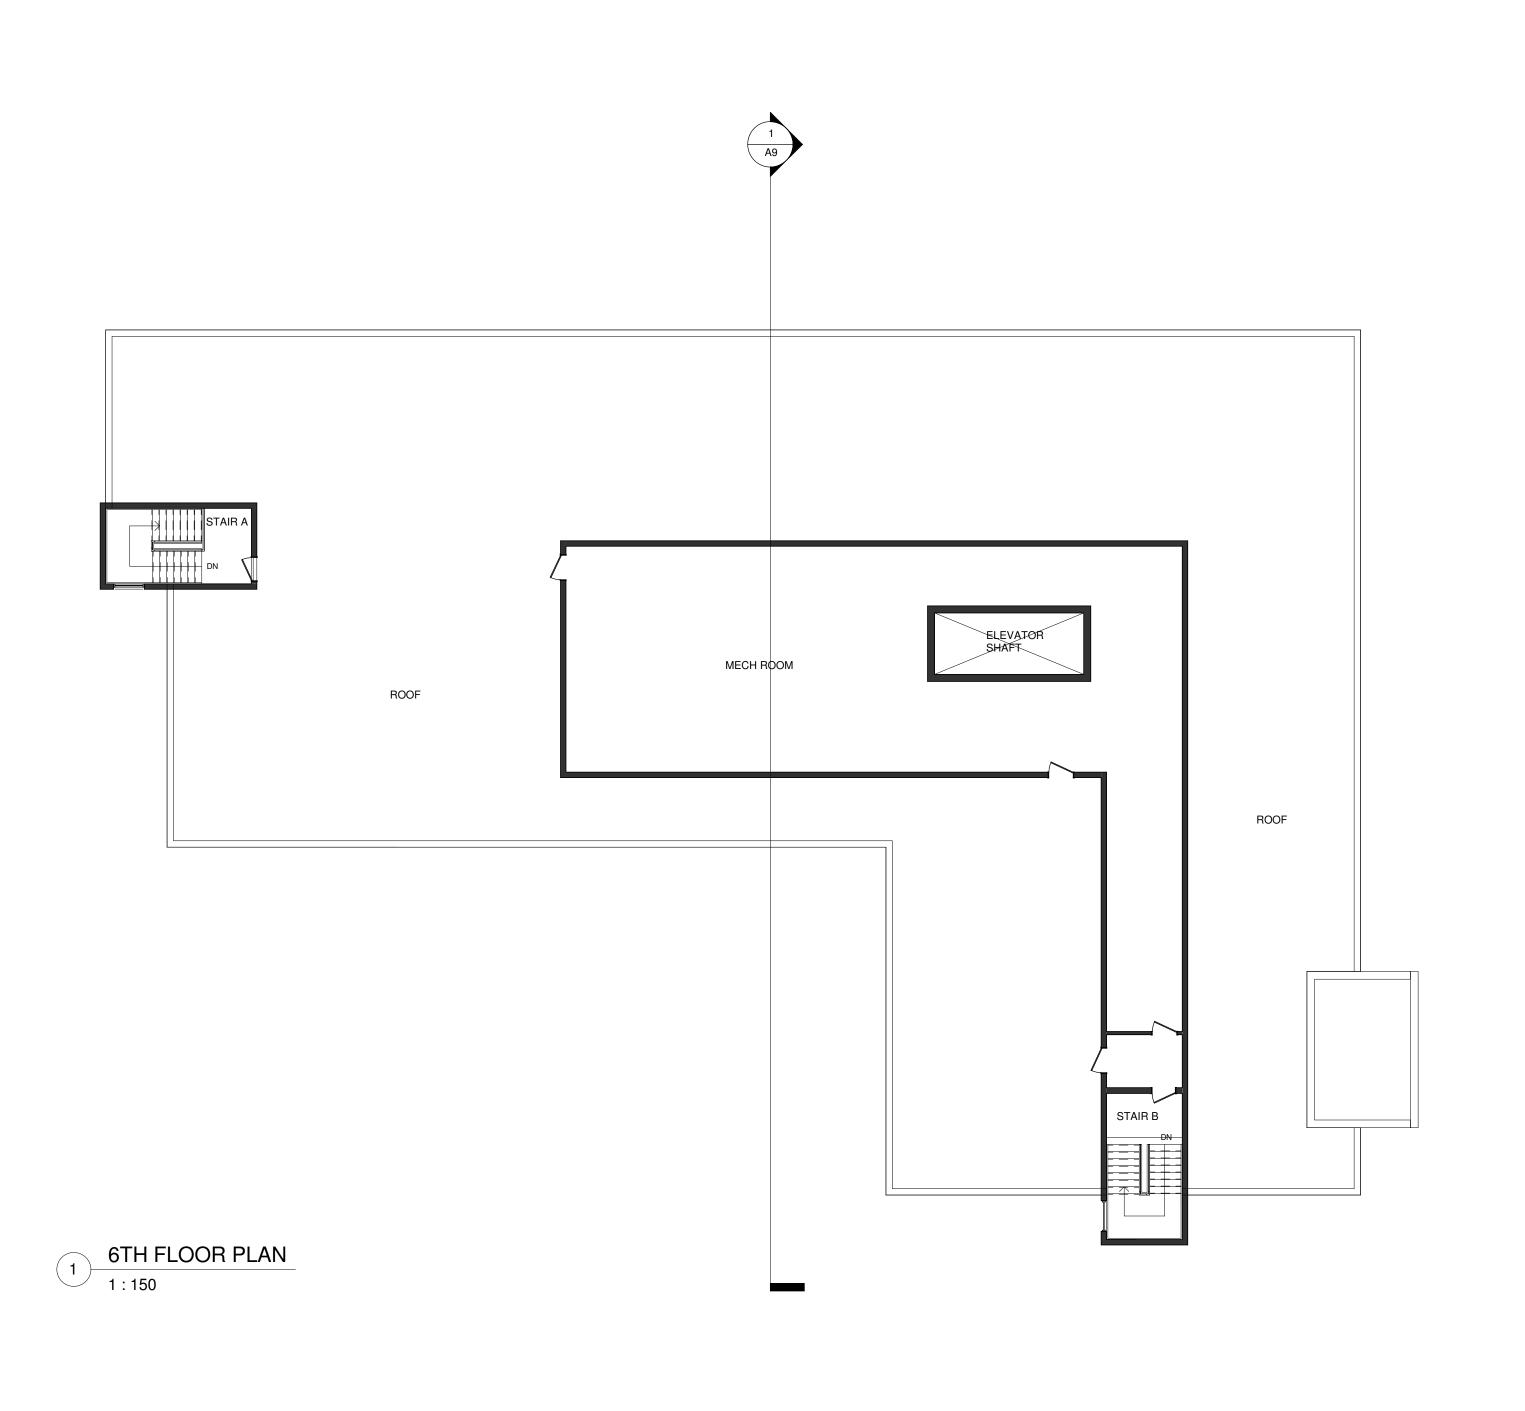

This drawing is provided by and is the property of AND Architecture Inc.. The contractor must verify all dimensions and conditions on site and must notify AND Architecture Inc. of any variations from the supplied information. This drawing is not to be scaled. The architect is not responsible for other consultants' information shown on this drawing. Refer to the appropriate consultant's drawings before proceeding with the work. Construction must conform to all applicable codes and requirements of authorities having jurisdiction. The contractor working from drawings not specifically marked 'For Construction' must assume full responsibility and bear costs for any corrections or damages resulting from his work.

6	SEPT. 1/22	REISSUED FOR SPA	HW
5	MAR 22/22	REISSUED FOR SPA	HW
4	NOV 23/20	REISSUED FOR SPA	HW
3	AUG 26/20	ISSUED FOR SPA	HW
2	MAY 06/20	ISSUED FOR REVIEW	HW
1	APR. 08/20	ISSUED FOR REVIEW	HW
No.	Date:	Issued/Revision:	Ву



AND Architecture Inc. 3950 14th Ave. Suite 609 Markham, ON L3R 0A9 T: 905-604-6960 E: info@andarchitectureinc.com www.andarchitectureinc.com

Project :

RIVERWOODS HOMES

RIVER ROAD WEST WASAGA BEACH, ON

Drawing Name :

MECH PENTHOUSE PLAN

Date	JUNE 2019	Project No :	18026
Scale:	1:150		
Drawn by :	Author	Drawing No :	A O
Checked by	y . Checker		A6



NORTH ELEVATION
1:150



This drawing is provided by and is the property of AND Architecture Inc.. The contractor must verify all dimensions and conditions on site and must notify AND Architecture Inc. of any variations from the supplied information. This drawing is not to be scaled. The architect is not responsible for other consultants' information shown on this drawing. Refer to the appropriate consultant's drawings before proceeding with the work. Construction must conform to all applicable codes and requirements of authorities having jurisdiction. The contractor working from drawings not specifically marked 'For Construction' must assume full responsibility and bear costs for any corrections or damages resulting from his work.

5	SEPT. 1/22	REISSUED FOR SPA	НΜ
4	MAR 22/22	REISSUED FOR SPA	НМ
3	AUG 26/20	ISSUED FOR SPA	НМ
2	MAY 06/20	ISSUED FOR REVIEW	НМ
1	APR. 08/20	ISSUED FOR REVIEW	НМ
Nο	Date:	Issued/Revision:	B _V



3950 14th Ave. Suite 609 Markham, ON L3R 0A9 T: 905-604-6960 E: info@andarchitectureinc.com www.andarchitectureinc.com

Project :

RIVERWOODS HOMES

RIVER ROAD WEST WASAGA BEACH, ON

Drawing Name:

NORTH & SOUTH **ELEVATIONS**

Date	JUNE 2019	Project No :	18026
Scale :	1:150		
Drawn by :	Author	Drawing No :	
Checked by	y . Checker		A/

SOUTH ELEVATION 1:150

TOP OF PARAPET 206.49 METAL SIDING -METAL SIDING MECH PENTHOUSE 202.53 METAL PANEL -METAL PANEL BRICK-Level 5 199.53 Level 4 196.53 - GLASS RAILING Level 3 193.53 PRECAST SILL -BRICK-Level 2 190.53 PRECAST BAND ARCH BLOCK — GLASS CURTAIN WALL Level 1 185.53 AVE. GRADE 184.97

EAST ELEVATION

TOP OF PARAPET 206.49 METAL SIDING -MECH PENTHOUSE 202.53 METAL PANEL -Level 5 199.53 Level 4 196.53 BRICK-GLASS RAILING -Level 3 193.53 Level 2 190.53 METAL PANEL -RIVERWOODS HOMES METAL SIDING ARCH BLOCK -Level 1 185.53 AVE. GRADE 184.97

WEST ELEVATION
1:150

This drawing is provided by and is the property of AND Architecture Inc.. The contractor must verify all dimensions and conditions on site and must notify AND Architecture Inc. of any variations from the supplied information. This drawing is not to be scaled. The architect is not responsible for other consultants' information shown on this drawing. Refer to the appropriate consultant's drawings before proceeding with the work. Construction must conform to all applicable codes and requirements of authorities having jurisdiction. The contractor working from drawings not specifically marked 'For Construction' must assume full responsibility and bear costs for any corrections or damages resulting from his work.

5	SEPT. 1/22	REISSUED FOR SPA	Н٧
4	NOV 23/20	REISSUED FOR SPA	Н۷
3	AUG 26/20	ISSUED FOR SPA	Н٧
2	MAY 06/20	ISSUED FOR REVIEW	Н٧
1	APR. 08/20	ISSUED FOR REVIEW	Н٧
No.	Date:	Issued/Revision:	Ву



3950 14th Ave. Suite 609
Markham, ON L3R 0A9
T: 905-604-6960
E: info@andarchitectureinc.com
www.andarchitectureinc.com

Project :


RIVERWOODS HOMES

RIVER ROAD WEST WASAGA BEACH, ON

Drawing Name :

EAST & WEST ELEVATIONS

Date JUNE 2019	Project No: 18026
Scale: 1:150	
Drawn by : Author	Drawing No :
Checked by : Checker	A8

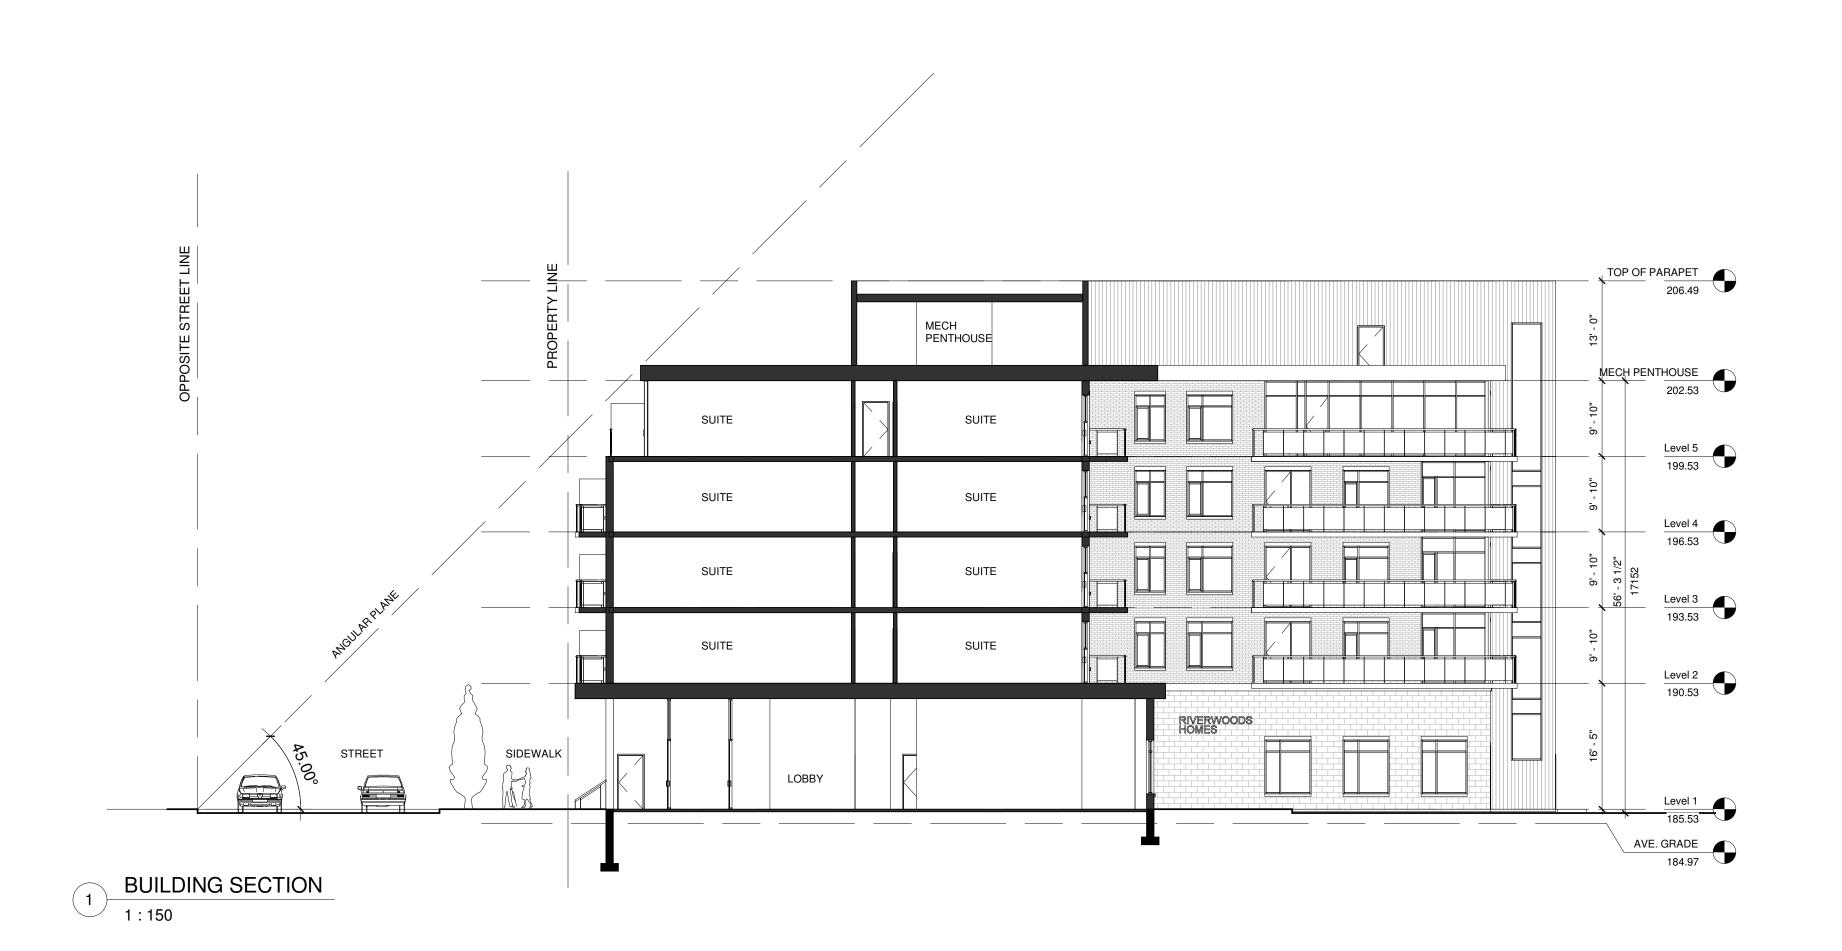

This drawing is provided by and is the property of AND Architecture Inc.. The contractor must verify all dimensions and conditions on site and must notify AND Architecture Inc. of any variations from the supplied information. This drawing is not to be scaled. The architect is not responsible for other consultants' information shown on this drawing. Refer to the appropriate consultant's drawings before proceeding with the work. Construction must conform to all applicable codes and requirements of authorities having jurisdiction. The contractor working from drawings not specifically marked 'For Construction' must assume full responsibility and bear costs for any corrections or damages resulting from his work.

4	SEPT. 1/22	REISSUED FOR SPA	Н٧
3	NOV 23/20	REISSUED FOR SPA	Н٧
2	AUG 26/20	ISSUED FOR SPA	Н٧
1	MAY 06/20	ISSUED FOR REVIEW	Н٧
No.	Date:	Issued/Revision:	Вν



AND Architecture Inc. 3950 14th Ave. Suite 609 Markham, ON L3R 0A9 T: 905-604-6960 E: info@andarchitectureinc.com

E: info@andarchitectureinc.com www.andarchitectureinc.com

Project :

RIVERWOODS HOMES

RIVER ROAD WEST WASAGA BEACH, ON

Drawing Name :

BUILDING SECTION

Date	JUNE 2019	Project No :	18026
Scale :		+	
Scale .	1:150		
Drawn by :	Author	Drawing No :	
Checked by	Checker		A9



This drawing is provided by and is the property of AND Architecture Inc..
The contractor must verify all dimensions and conditions on site and must notify AND Architecture Inc. of any variations from the supplied information. This drawing is not to be scaled. The architect is not responsible for other consultants' information shown on this drawing. Refer to the appropriate consultant's drawings before proceeding with the work. Construction must conform to all applicable codes and requirements of authorities having jurisdiction. The contractor working from drawings not specifically marked 'For Construction' must assume full responsibility and bear costs for any corrections or damages resulting from his work.

2	SEPT. 1/22	REISSUED FOR SPA	Н۷
1	MAR 22/22	REISSUED FOR SPA	Н۷
No.	Date:	Issued/Revision:	Ву



AND Architecture Inc. 3950 14th Ave. Suite 609 Markham, ON L3R 0A9 T: 905-604-6960 E: info@andarchitectureinc.com www.andarchitectureinc.com

Project :

RIVERWOODS HOMES

RIVER ROAD WEST WASAGA BEACH, ON

Drawing Name :

Date	JUNE 2019	Project No :	18026
Scale:			
Drawn by	: Author	Drawing No :	A 4 4
Checked	^{by :} Checker		A11



This drawing is provided by and is the property of AND Architecture Inc.. The contractor must verify all dimensions and conditions on site and must notify AND Architecture Inc. of any variations from the supplied information. This drawing is not to be scaled. The architect is not responsible for other consultants' information shown on this drawing. Refer to the appropriate consultant's drawings before proceeding with the work. Construction must conform to all applicable codes and requirements of authorities having jurisdiction. The contractor working from drawings not specifically marked 'For Construction' must assume full responsibility and bear costs for any corrections or damages resulting from his work.

2	SEPT. 1/22	REISSUED FOR SPA	HW
1	MAR 22/22	REISSUED FOR SPA	HW
No.	Date:	Issued/Revision:	Ву



AND Architecture Inc.
3950 14th Ave. Suite 609
Markham, ON L3R 0A9
T: 905-604-6960
E: info@andarchitectureinc.com
www.andarchitectureinc.com

Project :

RIVERWOODS HOMES

RIVER ROAD WEST WASAGA BEACH, ON

Drawing Name :

Date	JUNE 2019	Project No :	18026
Scale :			
Drawn by	: Author	Drawing No :	
Checked I	Oy : Checker		A12

2	2	SEPT. 1/22	REISSUED FOR SPA	Н
1	1	MAR 22/22	REISSUED FOR SPA	Н
Γ	No.	Date:	Issued/Revision:	Е

AND Architecture Inc. 3950 14th Ave. Suite 609 Markham, ON L3R 0A9 T: 905-604-6960 E: info@andarchitectureinc.com www.andarchitectureinc.com

Project :

RIVERWOODS HOMES

RIVER ROAD WEST WASAGA BEACH, ON

Drawing Name :

Date JUNE 2019	Project No: 18026
Scale:	-
Drawn by : Author	Drawing No :
Checked by : Checker	A13

This drawing is provided by and is the property of AND Architecture Inc.. The contractor must verify all dimensions and conditions on site and must notify AND Architecture Inc. of any variations from the supplied information. This drawing is not to be scaled. The architect is not responsible for other consultants information shown on this drawing. Refer to the appropriate consultants drawings before proceeding with the work. Construction must conform to all applicable codes and requirements of authorities having jurisdiction. The contractor working from drawings not specifically marked 'For Construction' must assume full responsibility and bear costs for any corrections or damages resulting from his work.

2	SEPT. 1/22	REISSUED FOR SPA	Н٧
1	MAR 22/22	REISSUED FOR SPA	Н٧
No.	Date:	Issued/Revision:	Ву



AND Architecture Inc.
3950 14th Ave. Suite 609
Markham, ON L3R 0A9
T: 905-604-6960
E: info@andarchitectureinc.com
www.andarchitectureinc.com

Project :

RIVERWOODS HOMES

RIVER ROAD WEST WASAGA BEACH, ON

Drawing Name :

Date	JUNE 2019	Project No :	18026
Scale :			
Drawn by :	Author	Drawing No :	A 4 4
Checked by	Checker		A14

This drawing is provided by and is the property of AND Architecture Inc..
The contractor must verify all dimensions and conditions on site and must notify AND Architecture Inc. of any variations from the supplied information. This drawing is not to be scaled. The architect is not responsible for other consultants' information shown on this drawing. Refer to the appropriate consultant's drawings before proceeding with the work. Construction must conform to all applicable codes and requirements of authorities having jurisdiction. The contractor working from drawings not specifically marked 'For Construction' must assume full responsibility and bear costs for any corrections or damages resulting from his work.

2	SEPT. 1/22	REISSUED FOR SPA	HW
1	MAR 22/22	REISSUED FOR SPA	HW
No.	Date:	Issued/Revision:	Ву



AND Architecture Inc.
3950 14th Ave. Suite 609
Markham, ON L3R 0A9
T: 905-604-6960
E: info@andarchitectureinc.com
www.andarchitectureinc.com

Project :

RIVERWOODS HOMES

RIVER ROAD WEST WASAGA BEACH, ON

Drawing Name :

Date	JUNE 2019	Project No :	18026
Scale :			
Drawn by	r: Author	Drawing No :	A 4 F
Checked	by : Checker		A15



2	SEPT. 1/22	REISSUED FOR SPA	HW
1	MAR 22/22	REISSUED FOR SPA	HW
Nο	Date:	Issued/Revision:	Βv



AND Architecture Inc.
3950 14th Ave. Suite 609
Markham, ON L3R 0A9
T: 905-604-6960
E: info@andarchitectureinc.com
www.andarchitectureinc.com

Project :

RIVERWOODS HOMES

RIVER ROAD WEST WASAGA BEACH, ON

Drawing Name :

3D VIEW

Date JUNE 2019	Project No :	18026
Scale:		
Drawn by : Author	Drawing No :	A 4 0
Checked by : Checker		A16

C:\Users\AND\Documents\Wasaga Riverwoods Homes - CURRENT 5-STOREY_JUE